BUCK RESIDENCE

444 MUNDELL WAY, LOS ALTOS, CA 94022

SHEET LIST - DESIGN REVIEW DRAWINGS			
Sheet Number	Sheet Name		
A000	COVER SHEET		
A001	PROJECT INFORMATION		
A100	DEMOLITION SITE PLAN		
A101	SITE PLAN		
LO	LANDSCAPE TITLE SHEET		
L1	LANDSCAPE PLAN		
L3	LANDSCAPE - NOTES/DETAILS		
A102	LOWER LEVEL AND FOUNDATION PLAN		
A103	ENTRY LEVEL FLOOR PLAN		
A104	ROOF PLAN		
A105	ELEVATIONS AND DAYLIGHT PLANE		
A106	ELEVATIONS		
A107	BUILDING SECTIONS		
A108	BUILDING SECTIONS		
SURVEY	SURVEY		
CIVIL	SITE GRADING, DRAINAGE, AND UTILITY PLAN		

APN: 167-14-031



1245 NIMITZ AVE. I MARE ISLAND, VALLEJO, CA 94592 I T: 886.887.7997

This document is intended for the singular view of the party to which Blu Homes has presented it. Any copying, distribution, or otherwise sharing of the text, images, or data therin expressed of this document is a violation of the terms to which said party has implicitly agreed upon by accepting this document.

© ALL RIGHTS RESERVED

FOR CONSULTANT USE:

BUCK RESIDENCE

444 Mundell Way Los Altos, CA 94022

CHERYL BUCK

cherylbuck26@gmail.com | 650.380.7215

ROBERT HARVEY
robert.harvey@bluhomes.com | 415.527.0936

PROJECT MANAGER: KEN ARENDS

ken.arends@bluhomes.com | 415.527.0966

SALES OPERATIONS: JOSEFINE KVIST

josefine.kvist@bluhomes.com | 415.527.0950

PROJECT ARCHITECT: KATRINA KUHL

katrina.kuhl@bluhomes.com | 707.563.9585

PROJECT DESIGNER: JOSHUA KEHL

joshua.kehl@bluhomes.com | 415.563.9592

Revision Date Description
07.30.2014 Planning Submittal Review
10.15.2014 Planning Submittal Review 2

NOT FOR CONSTRUCTION

DRAWING TITLE:

COVER SHEET


SCALE AT 22X34:

BLU MOD

BREEZEHOUSE + GLIDEPOD 25 + W-SERIES PURE GARAGE

PROJECT MODULE:

A000

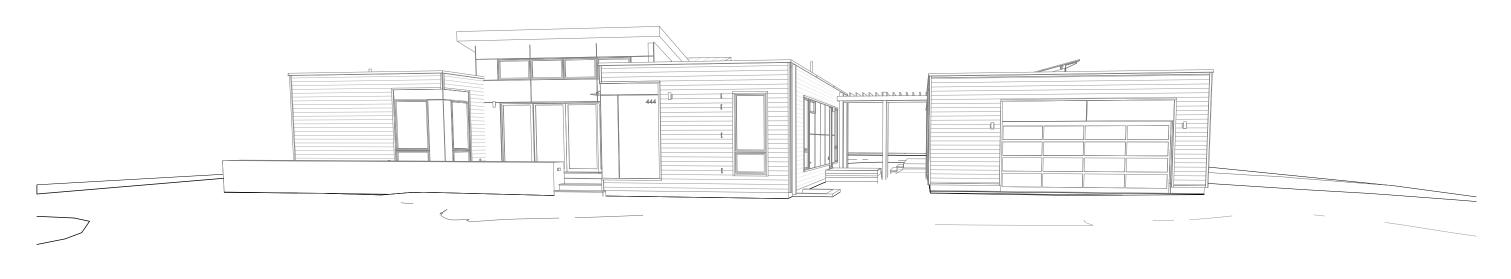

STREET VIEW - CAMERA @ 6' ABOVE GRADE

PROJECT INFORMATION

MANUFACTURER:	BLU HOMES 1245 NIMITZ AVE VALLEJO, CA 94592			
BUILDING INFORMATION				
PROJECT NAME:	BUCK RESIDENCE			
DESCRIPTION:	DEMOLITION OF EXISTING CARPORT, GARAGE, AND HOUSE ALONG WITH ANY HARDSCAPE, FENCES, AND ACCESSORY STRUCTURES.			
	NEW SINGLE STORY RESIDENTIAL UNIT APPROXIMATELY 53'-0" (L) X 56'-0" (W), ACCESSORY STRUCTURE 18'-6" (L) X 25'-0" (W), AND GARAGE 22'-4" (L) X 26'-4" (W)			
LOCATION ADDRESS:	444 MUNDELL WAY, LOS ALTOS, CA 94022			
APN:	167-14-031			
LOT AREA	19,139 SQFT (.44 ACRES)			
LOCAL JURISDICTION	CITY OF LOS ALTOS			
ZONING	CITY OF LOS ALTOS			
LOCAL REVIEW AGENCY:	CITY OF LOS ALTOS			
OCCUPANCY CLASS:	TYPE R1-10 - SINGLE FAMILY RESIDENTIAL			
SQUARE FOOT AREA:	HOUSE: 2,316 SF, STUDIO: 461 SF, GARAGE: 590 SF			
HEIGHT ABOVE FINISHED GRADE:	HOUSE: 17'-8" ABOVE FINISHED GRADE - UPPER ROOF, ONE STORY 12'-8" ABOVE FINISHED GRADE - FLAT ROOF, ONE STORY STUDIO: 17'-5" ABOVE FINISHED GRADE, ONE STORY GARAGE: 12'-11" ABOVE FINISHED GRADE, ONE STORY			

ZONING COMPLIANCE

	EXISTING	PROPOSED	ALLOWED/REQUIRED
LOT COVERAGE: (LAND AREA COVERED BY ALL STRUCTURES THAT ARE OVER 6 FEET IN HEIGHT)	2,260 SQUARE FEET (11.8 %)	3,438 SQUARE FEET (18.0 %)	6,698 SQUARE FEET (35 %)
FLOOR AREA: (MEASURED TO THE OUTSIDE OF SURFACES OF EXTERIOR WALLS)	1,708 SQUARE FEET (8.92 %)	3,332 SQUARE FEET (21. %)	4,330.7 SQUARE FEET (22.6 %)
SETBACKS: FRONT REAR RIGHT SIDE (1ST/2ND) LEFT SIDE (1ST/2ND)	25 FEET 25 FEET 10 FEET 10 FEET	25 FEET 25 FEET 10 FEET 10 FEET	25 FEET 25 FEET 10 FEET 10 FEET
HEIGHT	12 FEET	17.75 FEET	20 FEET


SQUARE FOOTAGE BREAKDOWN

	EXISTING	CHANGE IN	TOTAL PROPOSED
HABITABLE LIVING AREA: (INCLUDES HABITABLE BASEMENT AREAS)	1,104 SQUARE FEET	3,527 SQUARE FEET	3,527SQUARE FEET
NON-HABITABLE AREA: (DOES NOT INCLUDE COVERED PORCHES, GARAGES, OR OPEN STRUCTURES)	1,156 SQUARE FEET	588 SQUARE FEET	588 SQUARE FEET

LOT CALCULATIONS

NET LOT AREA:		15,807 SQUARE FEET (.37 ACRES)		
FRONT YARD HARDSCAPE AREA: (HARDSCAPE AREA IN THE FRONT YARD SE EXCEED 50%)	ETBACK SHALL NOT	836.5 SQUARE FEET (13.6 %) - PERMEABLE PAVERS (DRIVE AN - PLANTER - 74 SQFT - TOTAL FRONT YARD AREA - 6,13 *PERMEABLE PAVERS COUNT FO AREA -1,525 SQFT X 50% + 74 SQFT = 83	0 SQFT R 50% OF HARDSCAPE	
LANDSCAPING BREAKDOWN:	EXISTING SOFTSCAPE (UI NEW SOFTSCAPE AREA:	A (EXISTING AND PROPOSED): NDISTURBED) AREA: ULD EQUAL THE SITE'S NET LOT ARE	1,040.83 SQ FT 15,317.19 SQ FT - 551.02 SQ FT	

FLOOR AREA AND COVERAGE CALCULATIONS

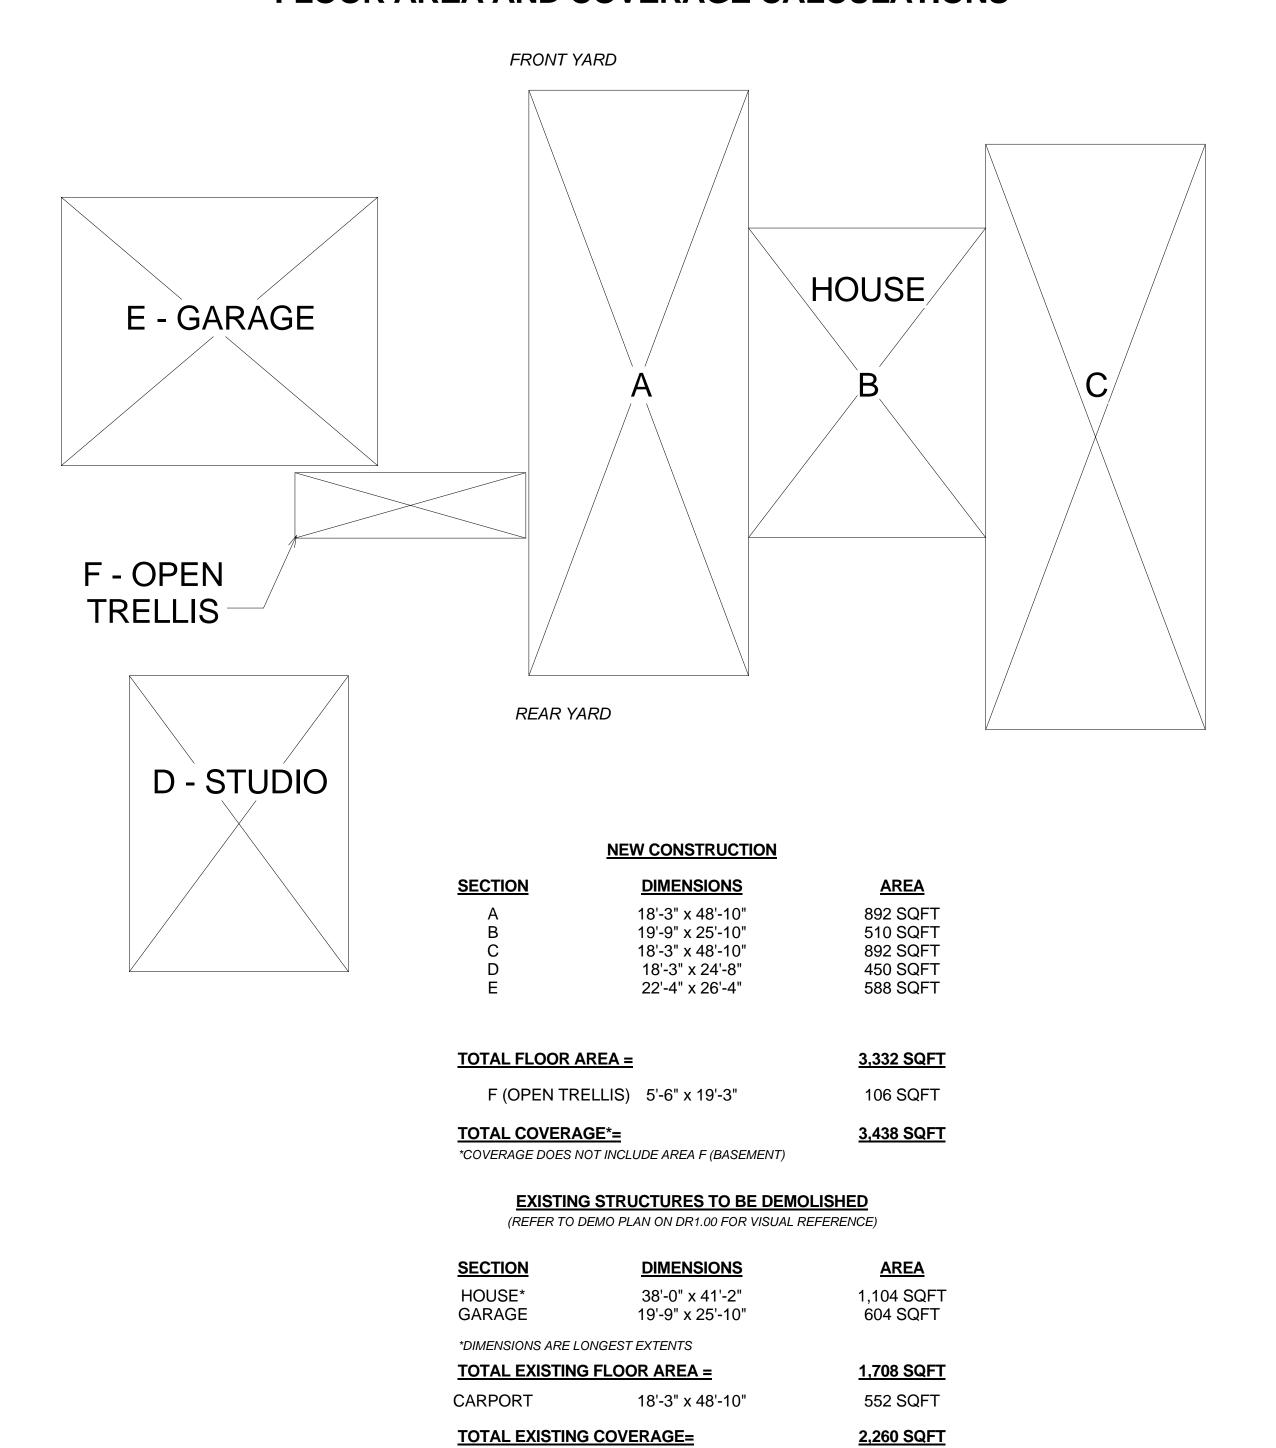

HOMES ®

bluhomes.com

This document is intended for the singular view of the party to which Blu Homes has presented it. Any copying, distribution, or otherwise sharing of the text, images, or data therin expressed of this document is a violation of the terms to which said party has implicitly agreed upon by accepting this document.

© ALL RIGHTS RESERVED

1245 NIMITZ AVE. I MARE ISLAND, VALLEJO, CA 94592 I T: 886.887.7997

FOR CONSULTANT USE:

BUCK RESIDENCE

444 Mundell Way Los Altos, CA 94022

CHERYL BUCK cherylbuck26@gmail.com | 650.380.7215

SALES REP: ROBERT HARVEY

PROJECT MANAGER: KEN ARENDS ken.arends@bluhomes.com | 415.527.0966

SALES OPERATIONS: JOSEFINE KVIST

josefine.kvist@bluhomes.com | 415.527.0950

T: KATRINA KUHL

katrina.kuhl@bluhomes.com | 707.563.9585

PROJECT DESIGNER: JOSHUA KEHL joshua.kehl@bluhomes.com | 415.563.9592

robert.harvey@bluhomes.com | 415.527.0936

Revision Date Description
07.30.2014 Planning Submittal Review
10.15.2014 Planning Submittal Review 2

NOT FOR CONSTRUCTION

DRAWING TITLE:

PROJECT INFORMATION

SCALE AT 22X34:


BLU MODUL

BREEZEHOUSE + GLIDEPOD 25 + W-SERIES PURE GARAGE

PROJECT MODULE:

HEET NUMBER:

A001

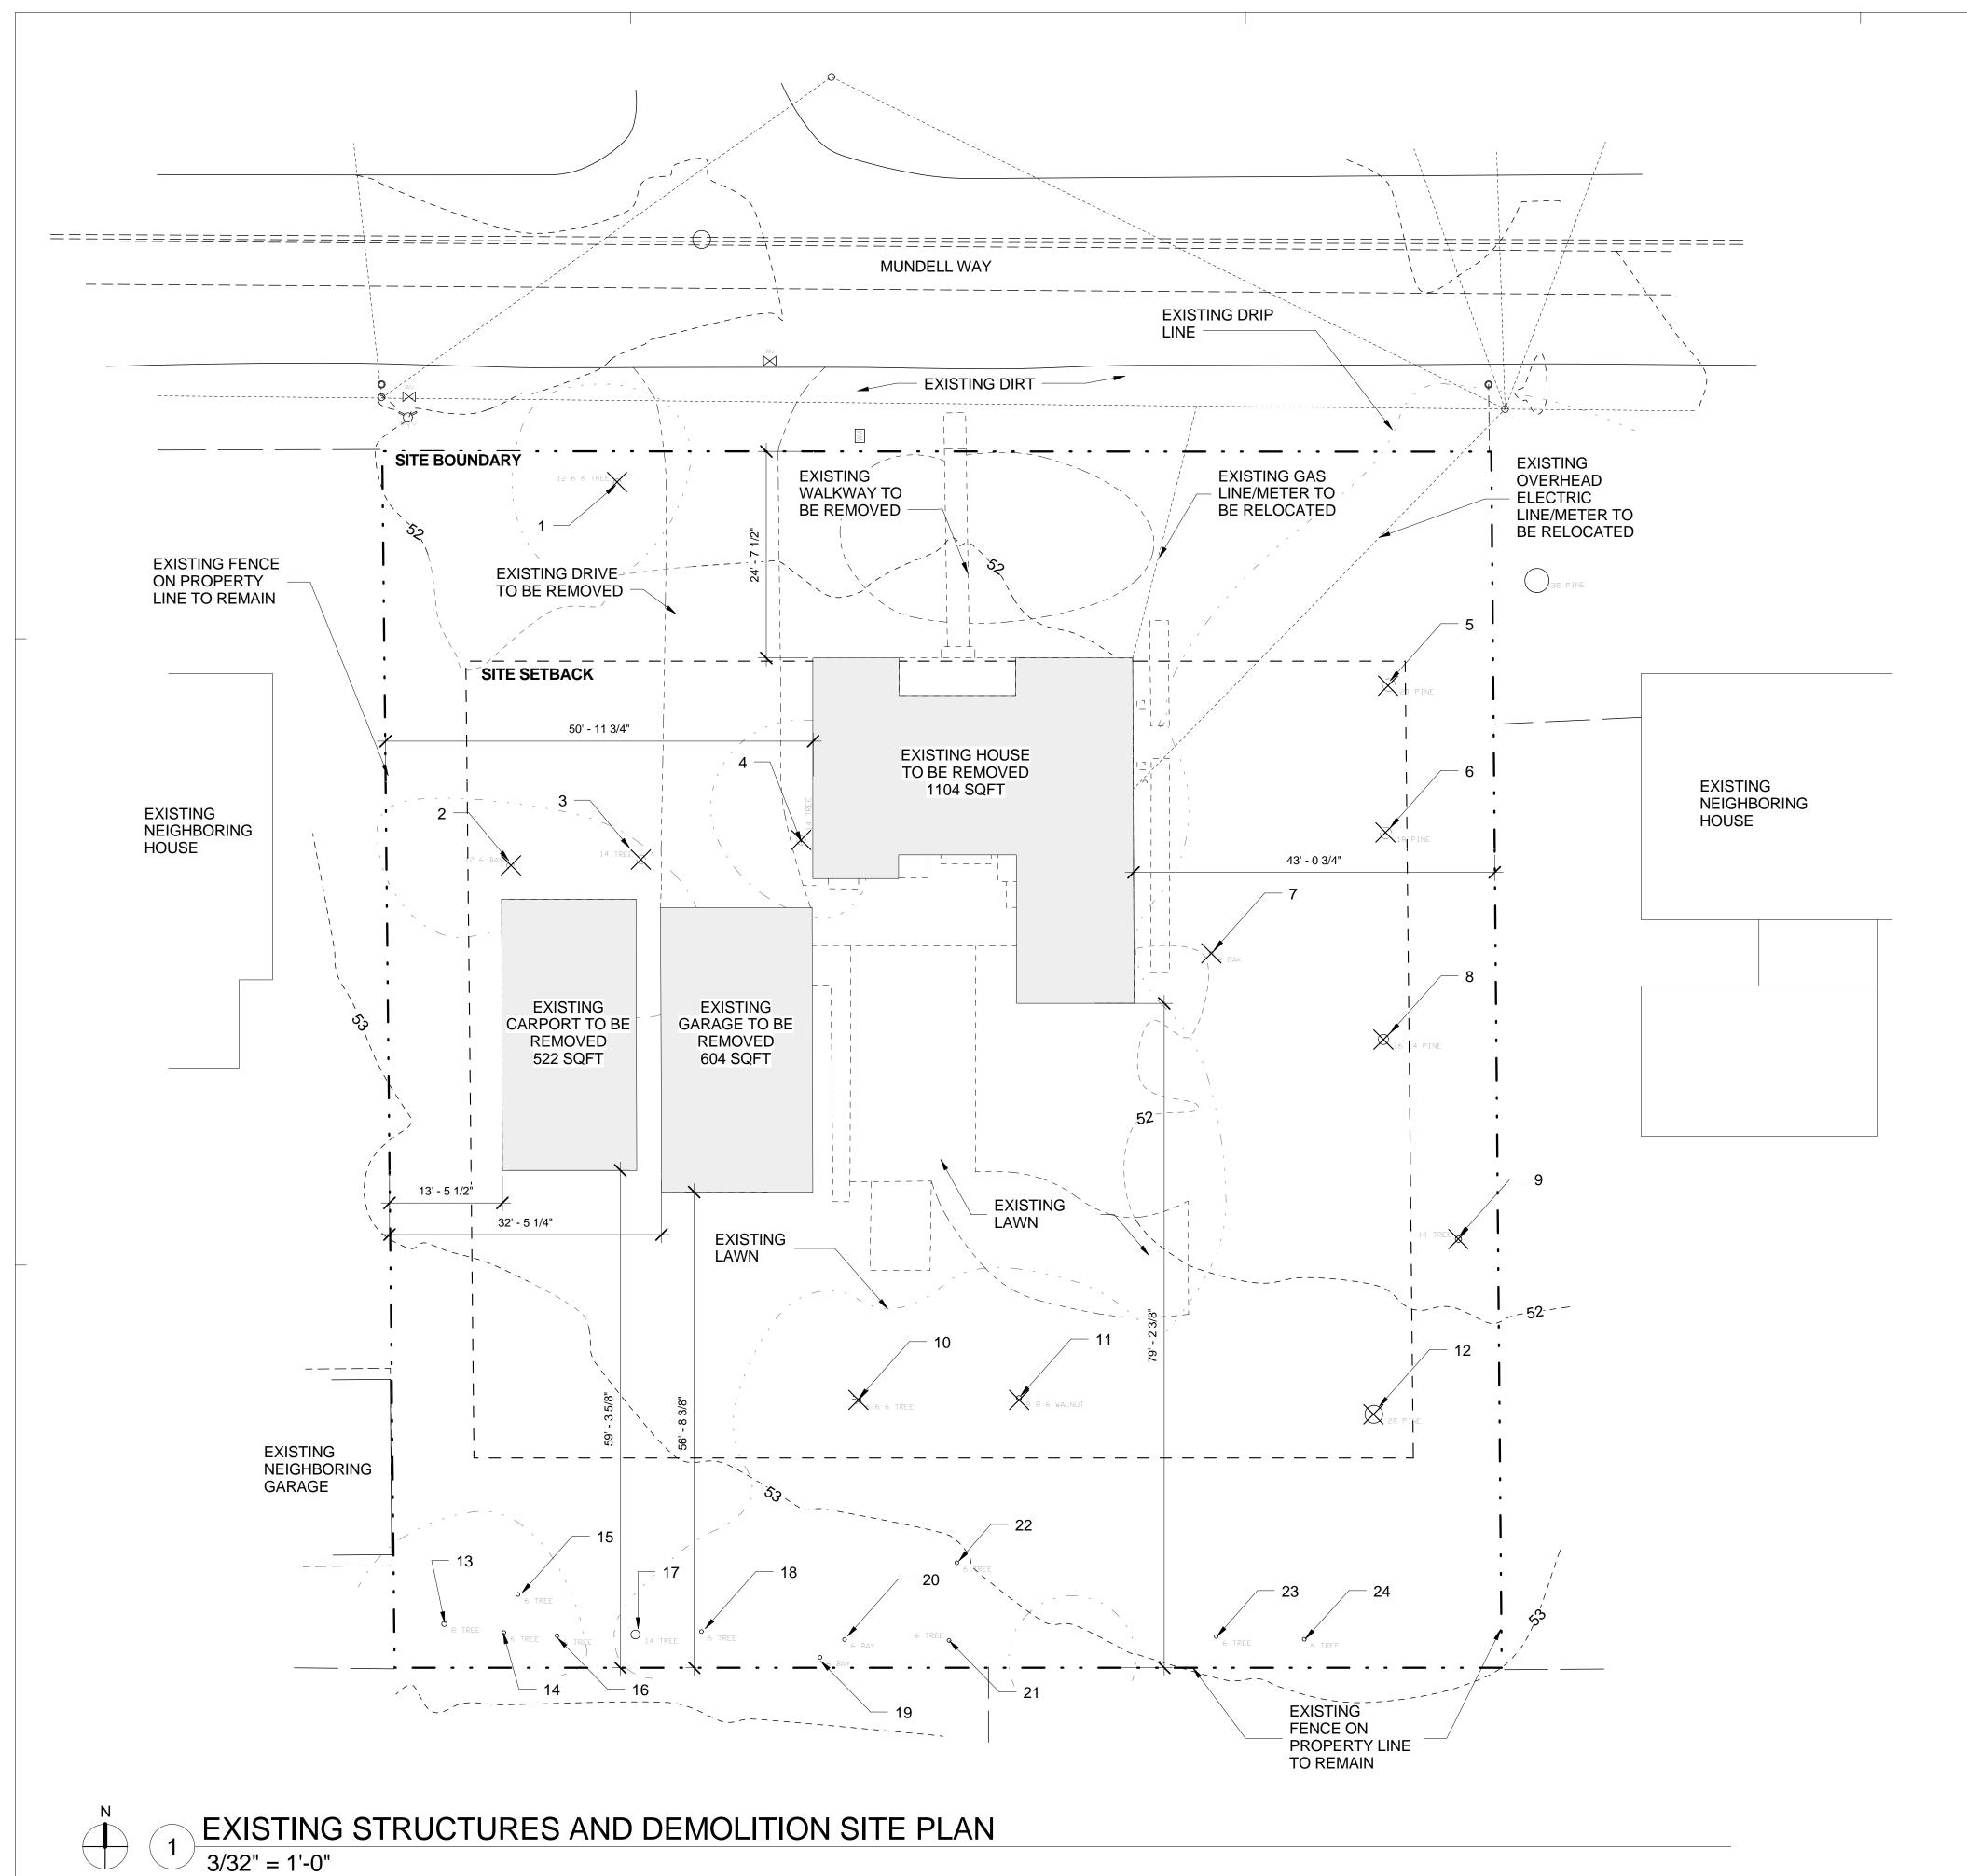

TREE PROTECTION PLAN

TREE #	SPECIES	SIZE (DIAMETER)	REMOVED/ RETAINED
1	UNKNOWN	12" 6" 6"	REMOVED
2	BAY	12" 6"	REMOVED
3	UNKNOWN	14"	REMOVED
4	UNKNOWN	14"	REMOVED
5	PINE	20"	REMOVED
6	PINE	18"	REMOVED
7	OAK	6"	REMOVED
8	PINE	16" 14"	REMOVED
9	UNKNOWN	10"	REMOVED
10	UNKNOWN	6" 6" 6"	REMOVED
11	WALNUT	8" 6" 6"	REMOVED
12	PINE	28"	REMOVED
13	UNKNOWN	8"	RETAINED
14	UNKNOWN	6"	RETAINED
15	UNKNOWN	6"	RETAINED
16	UNKNOWN	6"	RETAINED
17	UNKNOWN	19"	RETAINED
18	UNKNOWN	6"	RETAINED
19	BAY	6"	RETAINED
20	BAY	6"	RETAINED
21	UNKNOWN	6"	RETAINED
22	UNKNOWN	6"	RETAINED
23	UNKNOWN	6"	RETAINED
24	UNKNOWN	6"	RETAINED



bluhomes.com

1245 NIMITZ AVE. I MARE ISLAND, VALLEJO, CA 94592 I T: 886.887.7997

This document is intended for the singular view of the party to which Blu Homes has presented it. Any copying, distribution, or otherwise sharing of the text, images, or data therin expressed of this document is a violation of the terms to which said party has implicitly agreed upon by accepting this document.

© ALL RIGHTS RESERVED

FOR CONSULTANT USE:

BUCK RESIDENCE

444 Mundell Way Los Altos, CA 94022

CHERYL BUCK cherylbuck26@gmail.com | 650.380.7215

SALES REP: ROBERT HARVEY

robert.harvey@bluhomes.com | 415.527.0936

PROJECT MANAGER: KEN ARENDS

ken.arends@bluhomes.com | 415.527.0966

SALES OPERATIONS: JOSEFINE KVIST josefine.kvist@bluhomes.com | 415.527.0950

PROJECT ARCHITECT: KATRINA KUHL

katrina.kuhl@bluhomes.com | 707.563.9585

PROJECT DESIGNER: JOSHUA KEHL

joshua.kehl@bluhomes.com | 415.563.9592

Revision Date Description
07.30.2014 Planning Submittal Review
10.15.2014 Planning Submittal Review 2

NOT FOR CONSTRUCTION

DRAWING TITLE:

DEMOLITION SITE PLAN

SCALE AT 22X34:

BLU MOD


BREEZEHOUSE + GLIDEPOD 25 + W-SERIES PURE GARAGE

PROJECT MODULE:

CLIEFT NUMBER

A100

EXISTING INFORMATION BASED ON SURVEY DATED 11.06.2013 BY L. WADE HAMMOND, SEE SITE SURVEY ATTACHED, BACK OF SET

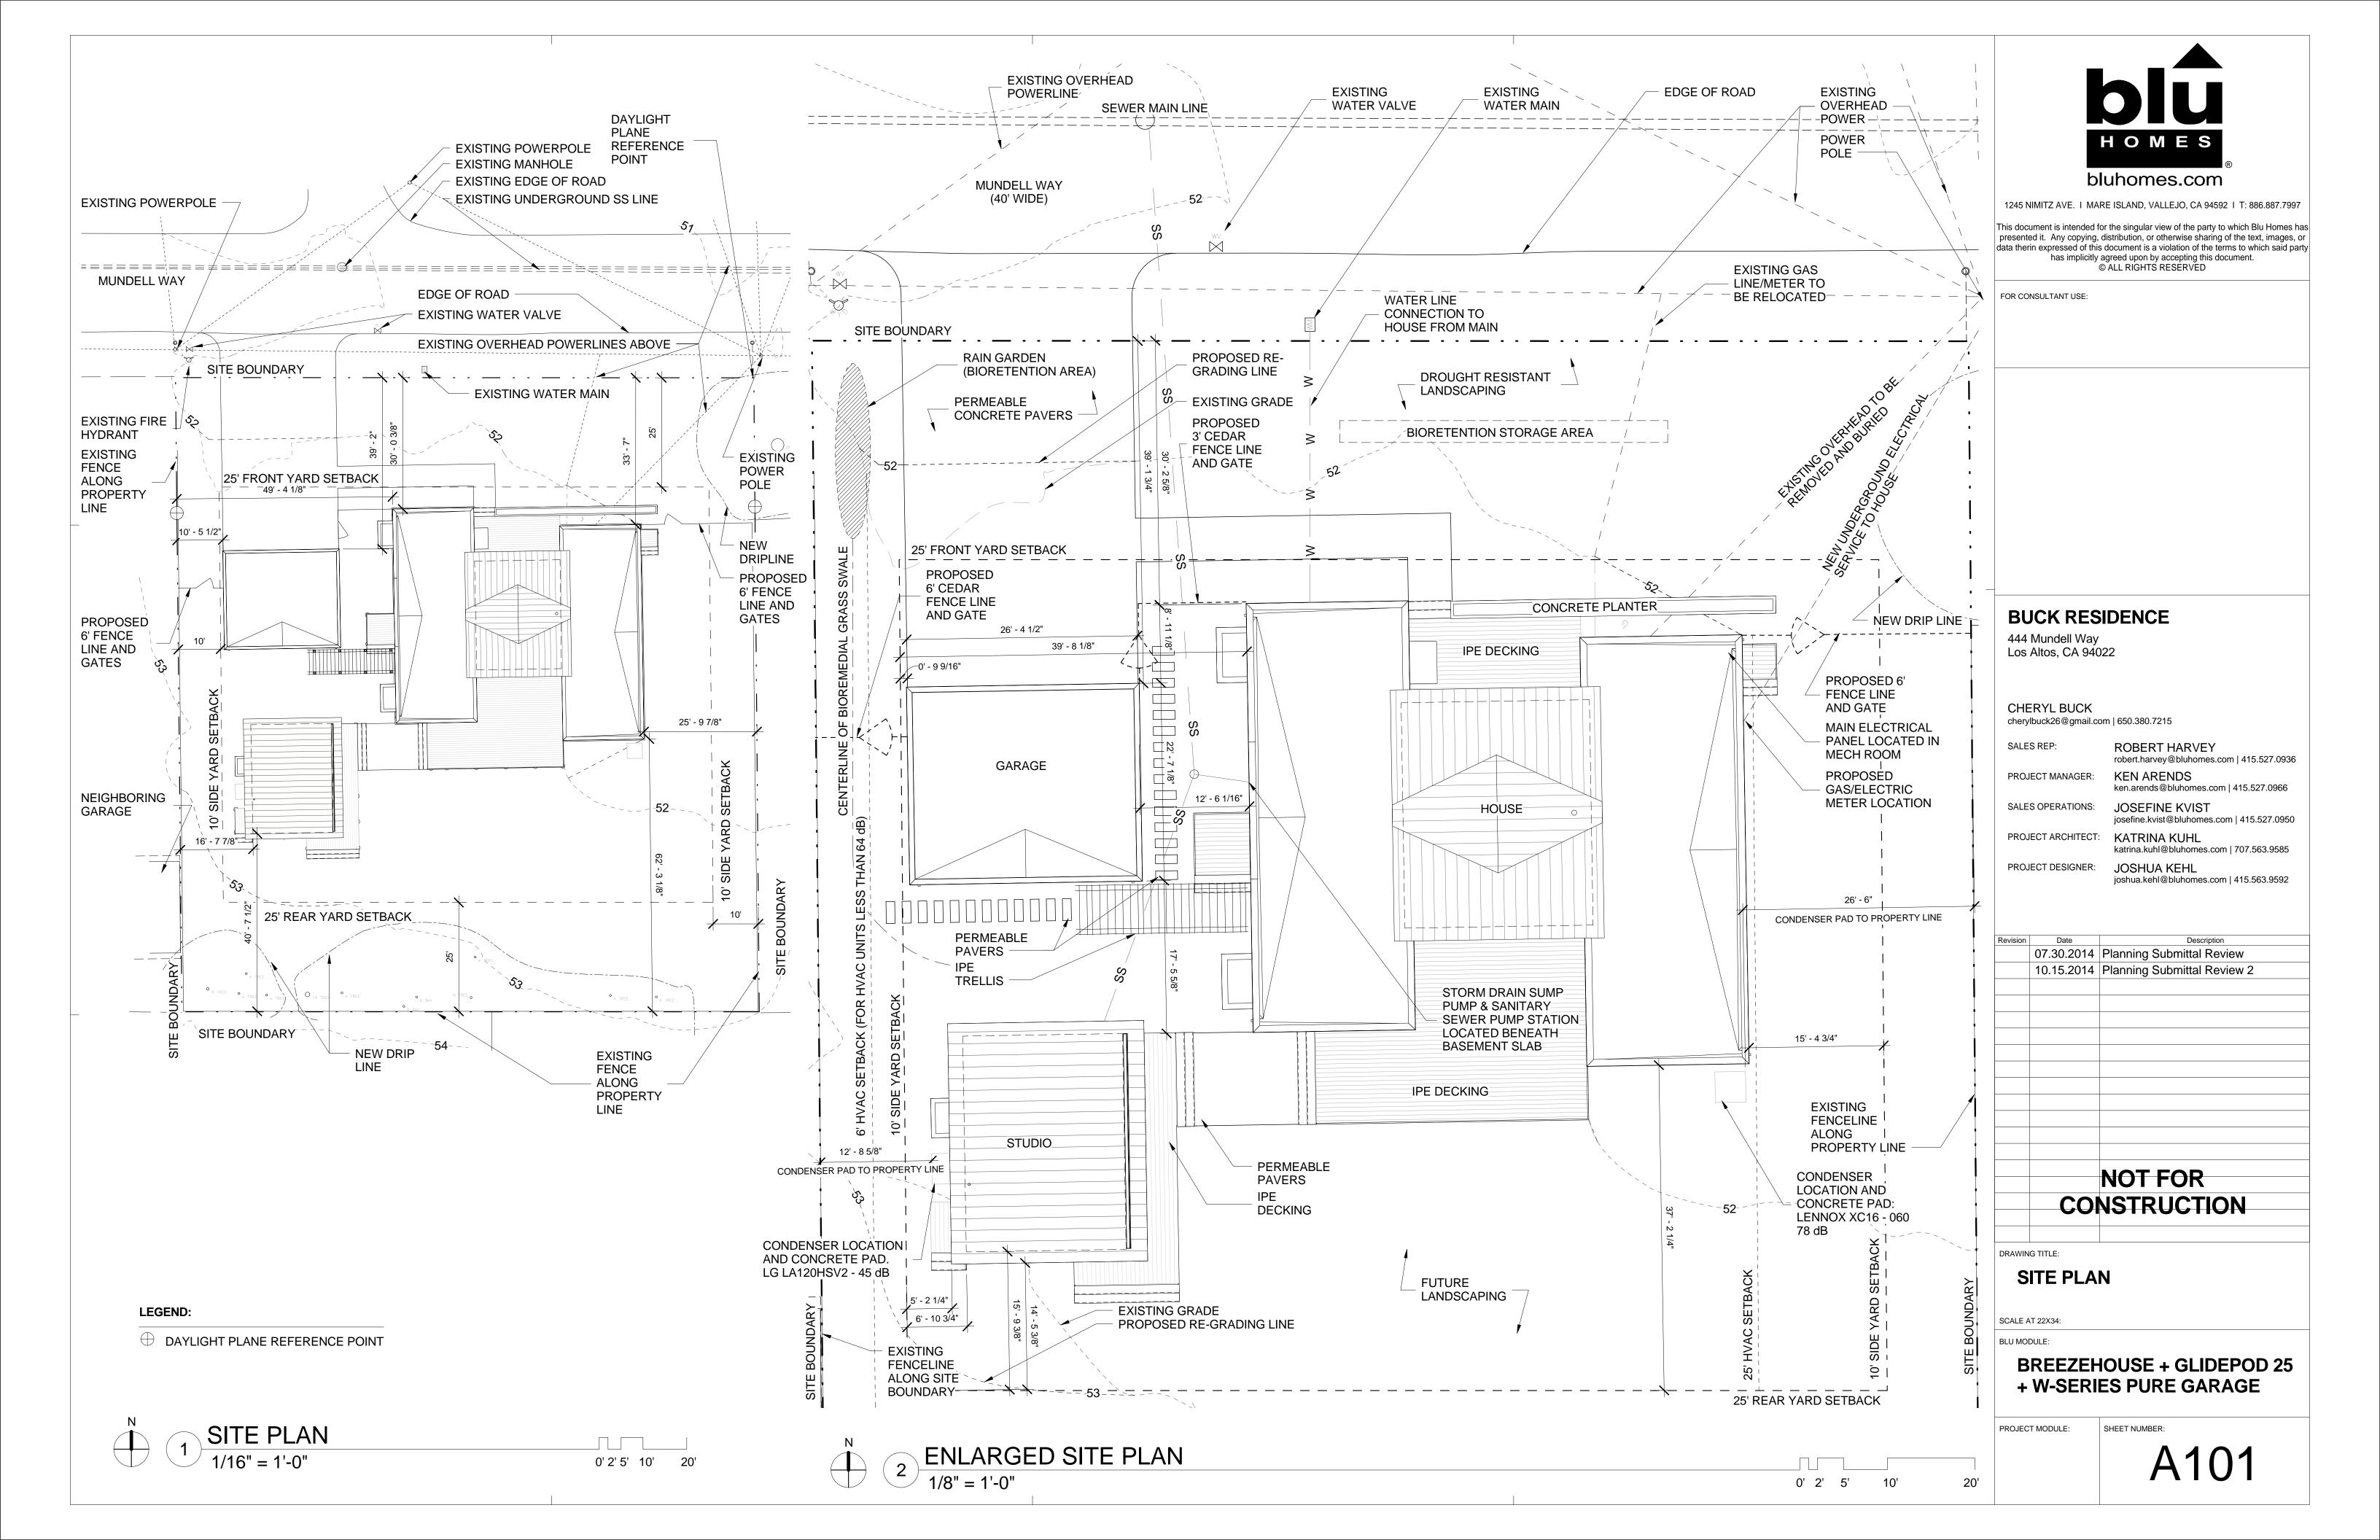



VICINITY MAP

444 MUNDELL WAY LOS ALTOS, CALIFORNIA




REGINA DESIGN LANDSCAPE ART

TABLE OF CONTENTS

L0 TITLE SHEET
L1 LANDSCAPE PLAN
L2 IRRIGATION PLAN

B DETAILS

NESIGN NESIGN

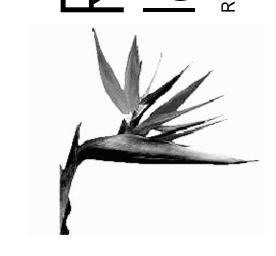

SCHEMATIC DESIGN

TITLE SHEET

SHEET TIT

444 MUNDELL WAY LOS ALTOS, CA

September 22, 2014

L0

DRAWING NO

GENERAL NOTES

THE LANDSCAPE CONCEPT PLAN IS BASED ON DRAWINGS PROVIDED BY FIRM DESIGN GROUP AND SITE MEASUREMENTS. THIS PROJECT HAS ALSO BEEN PROFESSIONALLY SURVEYED. 2. ANY MAJOR DISCREPANCIES SHOULD BE BROUGHT TO THE ATTENTION OF THE ARCHITECT IMMEDIATELY.

ALL WORK SHALL CONFIRM TO THE CURRENT STANDARDS, SPECIFICATIONS AND UNIFORM CONSTRUCTION STANDARDS OF SONOMA COUNTY.

GRADING NOTES

- 1. PRIOR TO INITIATING WORK, THE CONTRACTOR SHALL VERIFY ALL GRADES, UTILITY LOCATIONS, EXISTING DRAINAGE STRUCTURES, AND STREET IMPROVEMENTS.
- 2. IMMEDIATELY NOTIFY CITY ENGINEER OF ANY FIELD DISCREPANCIES WITH PLANS.
- 3. ALL PLANTED AREAS TO SLOPE TO AREA DRAINS AT A MINIMUM 2 % SLOPE UNLESS OTHERWISE NOTED.
- 4. ALL LANDSCAPE DRAINLINES TO FALL AT A MINIMUM 1 % SLOPE TO DRAINAGE. 5. FINISH GRADES IN PLANTED AREAS SHALL BE 1" BELOW TOP OF CURB OR PAVING IN SHRUB AREAS. 1% CROSS SLOPE UNLESS NOTED OTHERWISE. FINISH GRADE SHALL BE SET PRIOR TO PLANTING. ANY DISCREPANCY OR UNFINISHED AREAS SHALL BE BROUGHT TO THE
- ATTENTION OF ROLLIN LANDSCAPE DESIGN PRIOR TO PLANTING. 6. CONCRETE CONTRACTOR TO PROVIDE RISER AT FACE OF STOOP IF APPROACHING ENTRY
- WALKWAY EXCEEDS MAXIMUM ALLOWABLE SLOPE OF 5%. 7. ALL CONCRETE SHALL HAVE A MINIMUM 1% CROSS SLOPE OR AS NOTED ON PLANS

IRRIGATION NOTES:

- 1. THE IRRIGATION SYSTEM IS TO BE FULLY AUTOMATIC AND INCLUDE BACK FLOW PREVENTION AND RAIN SENSORS AT ROOF EVES IN STRATEGIC LOCATIONS.
- 2. ALL PLANTING IS TO BE IRRIGATED IN ACCORDANCE WITH SANTA CLARA COUNTY GUIDELINES.
- ALL PLANTING AREAS ARE TO BE IRRIGATED USING DRIP METHODS. 3. PLANTS WITH SIMILAR WATER REQUIREMENTS WILL BE GROUPED TOGETHER INTO DISTINCT,
- SEPARATE, HYDRO ZONES. 4. THE AVERAGE PLANT FACTOR FOR THE ENTIRE LANDSCAPE IS 0.3. THE PLANT FACTOR FOR
- MODERATE WATER-USING PLANTS (PLANTERS) IS 0.5. THE PLANT FACTOR FOR ALL OTHER LOW-WATER USING PLANTS IS 0.2.
- 5. ALL IRRIGATION EQUIPMENT TO BE INSTALLED PER TRADITIONAL STANDARDS.
- 6. IRRIGATION CONTROLLERS WILL HAVE REPEAT START TIMES AND MULTIPLE-PROGRAM POTENTIAL; AND AN AUTOMATIC RAIN SHUTOFF DEVICE FOR EACH CONTROLLER; PRESSURE REGULATION DEVICE(S) AS REQUIRED TO EFFECT APPROPRIATE OPERATING PRESSURES FOR EACH TYPE OF SPRINKLER OR OTHER APPLICATION DEVICE;
- 7. SEPARATE IRRIGATION CIRCUITS SHALL BE INSTALLED FOR DIFFERENT HYDROZONES, IRRIGATION METHODS, PRECIPITATION RATES, SOLAR EXPOSURES, MICROCLIMATES, SLOPES
- 8. THE IRRIGATION PLAN WILL BE DIAGRAMMATIC: ALL VALVES AND SYSTEM EQUIPMENT SHALL
- BE LOCATED IN SHRUB AREAS WHEREVER POSSIBLE. 9. THE IRRIGATION SYSTEM SHALL BE INSTALLED BY A LICENSED CONTRACTOR IN

CONFORMANCE WITH ALL APPLICABLE STATE AND LOCAL CODES/ORDINANCES.

- 10. THE CONTRACTOR SHALL OBTAIN AND PAY FOR ALL REQUIRED PERMITS AND FEES RELATED TO HIS WORK ON THE PROJECT. 11. THE IRRIGATION CONTRACTOR SHALL VERIFY STATIC WATER PRESSURE, SERVICE LINE SIZE,
- AND WATER METER SIZE PRIOR TO CONSTRUCTION. 12. ALL MAINLINE PIPING AND CONTROL WIRES UNDER PAVING OR WALLS SHALL BE INSTALLED IN
- SEPARATE SLEEVES. MAINLINE SLEEVES SHALL BE A MINIMUM OF TWICE (2X) THE DIAMETER OF THE PIPE TO BE SLEEVED. CONTROL WIRE SLEEVES SHALL BE OF SUFFICIENT SIZE (MINIMUM 1" SIZE) FOR THE REQUIRED NUMBER OF WIRES UNDER PAVING.
- 13. ALL EXCAVATIONS ARE TO BE BACKFILLED TO 85% COMPACTION (95% UNDER PAVING) UNLESS
- 14. THE CONTRACTOR SHALL REVIEW AND VERIFY THE LOCATION AND TYPE OF ELECTRICAL POWER SOURCE IN THE FIELD WITH THE OWNER'S REPRESENTATIVE AND THE IRRIGATION DRAWINGS. ANY DISCREPANCIES MUST BE REPORTED TO BOTH THE OWNER'S REPRESENTATIVE AND ROLLIN LANDSCAPE DESIGN THE CONTRACTOR SHALL OBTAIN THE APPROVAL OF ALL CONTROLLER LOCATIONS PRIOR TO INSTALLATION AND SHALL MAKE THE
- FINAL CONNECTION FROM THE ELECTRICAL SOURCE TO THE CONTROLLER(S). 15. IRRIGATION CONTROL WIRE SHALL BE #14-1, U.L. APPROVED FOR DIRECT BURIAL. COMMON WIRE SHALL BE WHITE IN COLOR AND PILOT WIRES SHALL BE A COLOR OTHER THAN WHITE.
- 16. ALL WIRE SPLICES SHALL BE MADE WITHIN VALVE BOXES. SPLICES SHALL BE MADE WITH A COPPER CRIMP-TYPE CONNECTOR AND INSTALLED WITHIN '3M' #DBY SEALING PACK, OR AN APPROVED EQUAL.

Salvia nemorosa

GENERAL PLANTING NOTES


- 1. PLANT MATERIAL HAS BEEN SELECTED TO PROVIDE PRIVACY SCREENING, SOFTEN THE PROPOSED ARCHITECTURAL FEATURES, BLEND INTO THE NATURAL SETTING AND AS A SLOPE
- STABILIZATION METHOD. PLANTS ARE MOSTLY NATIVE AND NEED GOOD DRAINAGE. 2. PLANTS SELECTED ARE COMPATIBLE WITH THE CLIMATE, GEOLOGY AND TOPOGRAPHIC CONDITIONS OF THE SITE. PLANTS WITH SIMILAR WATER EQUIREMENTS ARE GROUPED TOGETHER IN DISTINCT AND SEPARATE HYDROZONES. PLANTS IN THE LOW WATER HYDROZONE MAY NEED THEIR IRRIGATION TO BE DISCONTINUED ONE YEAR AFTER
- 3. LANDSCAPED AREAS ARE WATER CONSERVING AND IRRIGATED WITH AN AUTOMATIC IRRIGATION SYSTEM THAT IS DESIGNED TO PROVIDE EFFICIENT IRRIGATION COVERAGE
- WITHOUT OVERSPRAY ONTO NON-LANDSCAPED AREAS. 4. CONTRACTOR SHALL VERIFY ALL PLANT MATERIAL QUANTITIES PRIOR TO INSTALLATION.
- 5. PLANT MATERIAL QUANTITIES ARE LISTED FOR THE CONVENIENCE OF THE CONTRACTOR. 6. THE ACTUAL NUMBER OF SYMBOLS SHALL HAVE PRIORITY OVER QUANTITY DESIGNATED. 7. VERIFY EXISTING GRADE IN FIELD PRIOR TO PLANTING. EXISTING GRADE SHALL BE WITHIN ± ONE TENTH (1/10) OF A FOOT OF FINISH GRADE. FINISH GRADE SHALL BE 1 INCH BELOW TOP OF
- CURB AND 2 INCHES BELOW TOP OF CURB OR PAVING IN GROUND COVER AREAS. 8. PRIOR TO PLANTING, THE IRRIGATION SYSTEM SHALL BE FULLY OPERATIONAL. THOROUGHLY WATER ALL PLANTS IMMEDIATELY AFTER PLANTING.
- 9. PRIOR TO EXCAVATION, CONTRACTOR SHALL VERIFY LOCATIONS OF UNDERGROUND
- 10. PRIOR TO INSTALLATION, ALL PLANT MATERIALS SHALL BE SUBJECT TO APPROVAL BY ROLLIN LANDSCAPE DESIGN AND/OR THE OWNER'S REPRESENTATIVE. PLANT MATERIALS REJECTED FOR THE PROJECT SHALL BE IMMEDIATELY REMOVED FROM THE SITE.
- 11. ROLLIN LANDSCAPE DESIGN SHALL APPROVE ALL TREE LOCATIONS PRIOR TO INSTALLATION. 12. CONTRACTOR TO CONTACT ROLLIN LANDSCAPE DESIGN MIN. 72 HOURS PRIOR TO SCHEDULE TREE APPROVAL SITE VISIT. ANY AND ALL TREES INSTALLED COULD BE SUBJECT TO RELOCATION AT CONTRACTOR'S EXPENSE.
- 13. PRIOR TO PLANTING, ALL PLANTING AREAS SHALL BE FREE OF WEEDS, ROCKS, AND DEBRIS. 14. THE SOILS AMENDMENTS SPECIFIED HEREIN ARE FOR BIDDING PURPOSES ONLY.
- 15. FOR THE AREA TO BE LANDSCAPED THE FOLLOWING AMENDMENTS SHALL BE CROSS RIPPED OR EQUALLY CULTIVATED BY MEANS OF ROTOTILLING A UNIFORM DEPTH OF 12 INCHES AS FOLLOWS, EXCEPT IN AREAS WITH SLOPES OF 3:1 OR GREATER. IN THESE AREAS AMENDMENTS SHOULD BE INSTALLED OR ADDED PER PLANTING DETAILS FOR EACH
- AMOUNT PER 1,000 SQUARE FEET -4 CU YDS. NITROGEN STABILIZED ORGANIC AMENDMENT DERIVED FROM REDWOOD, FIR, OR
- CEDAR SAWDUST. 35LBS. 6-20-20 PELLETIZED FERTILIZER
- 100LBS. AGRICULTURAL GYPSUM
- 13 LBS. SOIL SULFUR 16. THE PLANTING PIT PERIMETERS FOR TREES AND SHRUBS SHALL BE EXCAVATED TO TWICE THE DIAMETER OF THE ROOTBALL, AS NOTED AND SHOWN ON THE PLANTING DETAILS. THE PITS
- SHALL BE SCARIFIED. 17. THE ROOTBALL SHALL BE SET ON UNDISTURBED SOIL AND THE CROWN SHALL BE SET 1" ABOVE FINISH GRADE. A 3" BERM SHALL BE CREATED AROUND THE PLANT PIT AND MULCHED WITH 2" MINIMUM BARK MULCH
- -6 PARTS ON-SITE SOIL -4 PARTS BY VOLUME ORGANIC AMENDMENT PER ABOVE (#9) SOIL PREP MIX. -2 LBS/CU. YD. MIX OF 6-20-20 IRON SULFATE
- -5 LBS/CU. YD. MIX AGRICULTURAL GYPSUM) 18. THIRTY DAYS AFTER INSTALLATION ALL LANDSCAPE AREAS SHALL BE FERTILIZED WITH APPROVED 16-6-8 FERTILIZERS APPLIED AT A RATE OF SIX (6) POUNDS PER 1000 SQ.FT.
- FERTILIZER APPLICATION SHALL BE CONTINUED THEREAFTER AT 60-DAY INTERVALS. 19. FERTILIZER TABLETS SHALL BE AGRIFORM, 21 GRAM TABLETS (20-10-5) OR EQUAL IN QUANTITIES AS FOLLOWS:
- -1 GALLON SHRUB 1
- -5 GALLON SHRUB 3
- -15 GALLON SHRUB OR TREE 4
- -24" BOX TREE & LARGER 1 PER 4" OF BOX SIZE 20. -PLACE TABLETS AT HALF THE DEPTH OF THE ROOTBALL.
- 21. ALL SHRUB AND FALLOW AREAS TO RECEIVE 2" MINIMUM DEPTH OF SHREDDED RECYCLED
- 22. PRIOR TO COMPLETION, ROLLIN LANDSCAPE DESIGN SHALL REVIEW THE PROJECT
- 23. LANDSCAPE SHALL BE INSTALLED IN ACCORDANCE WITH THE PLANS AND SPECIFICATIONS. THE CONTRACTOR SHALL NOTIFY ROLLIN LANDSCAPE DESIGN A MINIMUM OF 72 HOURS PRIOR
- TO A SITE VISIT. 24. TREE SETBACKS SHALL BE:
- -6' FROM PAVED SURFACES -5' FROM WATER METERS AND JOINT TRENCHES
- -7' FROM STREETLIGHTS
- -10' FROM SANITARY SEWER LINES OR SEPTIC LINES AND LEACHFIELD 25. ALL TREES PLANTED WITHIN 5' OF PAVING, WATER METERS, OR JOINT TRENCHES SHALL RECEIVE POLYETHELYENE RS24 LINEAR ROOT BARRIERS AS MANUFACTURED BY ROOT SOLUTIONS (800) 554-0914.
- 26. THE CONTRACTOR SHALL GUARANTEE THAT ALL SHRUBS ARE FREE FROM DEFECT IN MATERIAL OR WORKMANSHIP FOR A PERIOD OF 90 DAYS AFTER FINAL ACCEPTANCE OF WORK. 27. ROLLIN LANDSCAPE DESIGN SHALL BE PRESENT FOR SITING OF TREES - AT LEAST 48 HOURS
- ADVANCE NOTICE REQUIRED. 28. PLANT COUNT FOR BIDDING PURPOSES ONLY. CONTRACTOR TO VERIFY PLANT QUANTITY JIRED. CONTACT ROLLIN LANDSCAPE DESIGN WITH ANY DISCREPANCIES

	REQUI
29	

Botanical Name	cultivar	Plant list for 444 Mundell Way Los Common Name	abbr.	Size	Number	Native Plant	Low Water Use Plan
_							
Trees							
Arbutus Marina	Marina	Strawberry Tree	Α	36" bov	2	x	x
Aesculus californica		Red Horse chestnut	HC	36'box	2	X	X
Acer cirfinatum	Acer cirfinatum	Vine Maple	VM	24" box	1	X	X
1alus X	Spring Snow	Spring Snow Crabapple	С	24" box	3		Х
Fruit Trees							
Apple	Pink Pearl		FT	24"	1		when established
Apricot	Autumn Glow		FT	24"	1		×
ig	Peter's Honey		FT	24"	1		×
.emon	Meyer		FT	24"	1		X
Navel Orange	Washington		FT	24"	1		X
Peach	Alberta		FT	24"	1		X
Plum	Santa Rosa		FT	24"	1		X
Tangerine	Dancy		FT	24"	1		x
Shrubs							
Ceanothus	'Ray Hartman	California Lilac	CR	15 gallon	18	×	x
Ceanothus griseus horizontalis	'Horizontalis	Carmel Creeper California Lilac	CE	5 gallon	7	X	×
Rhamnus californica		Coffee Berry	СВ	5 gallon	6	x	x
Grass-like Plants							
			CH	15 gallon	18		X
Chondropetalum t.	El Campo		M	5 gallon	55		X
discanthus sinensis	Gracilimus			o ganon	33		^
Meadow							
Grasses							
Calamagrostis nutkaensis		Pacific Reedgrass	-	1 gallon	60	x	X
Hordeum brachyantherum ssp. californicum		feather fingergrass	-	1 gallon	60	X	X
omandra longifolia		Breeze Grass	-	1 gallon	90	x	×
Muhlenbergia rigens		Deer Grass	-	5 gallon	30	x	X
Pennisetum orientale	'Fairy tales	Fairy tales fountain grass	-	1 gallon	90	×	x
lowers							
Achillea millefolium	Paprika	Yarrow		1 gallon	120	x	X
Agastache	'Black Adder'	Anise Hyssop		1 gallon	90		X
Allium sphaerocephalon		Drumstick Allium	-	bulbs	200		X
schscholzia Californica	Apricot Chiffon	California Poppy	_	seeds		×	X
Eschscholzia Californica	Rose Chiffon	California Poppy		seeds		x	x
Penstemon neterophylus	Neterophylus	'Blue Springs Penstemon'		1 gallon	60	x	x
Penstemon Midnight	Midnight	Midnight Penstemon		1 gallon	90	x	x
Perovskia atriplicifolia	Little Spire	Little spires Russian sage		1 gallon	60		X
		_ cas op. oo . assian sage		2 9311011	60		

Amethyst meadow sage

Negrito, Sensation Rose

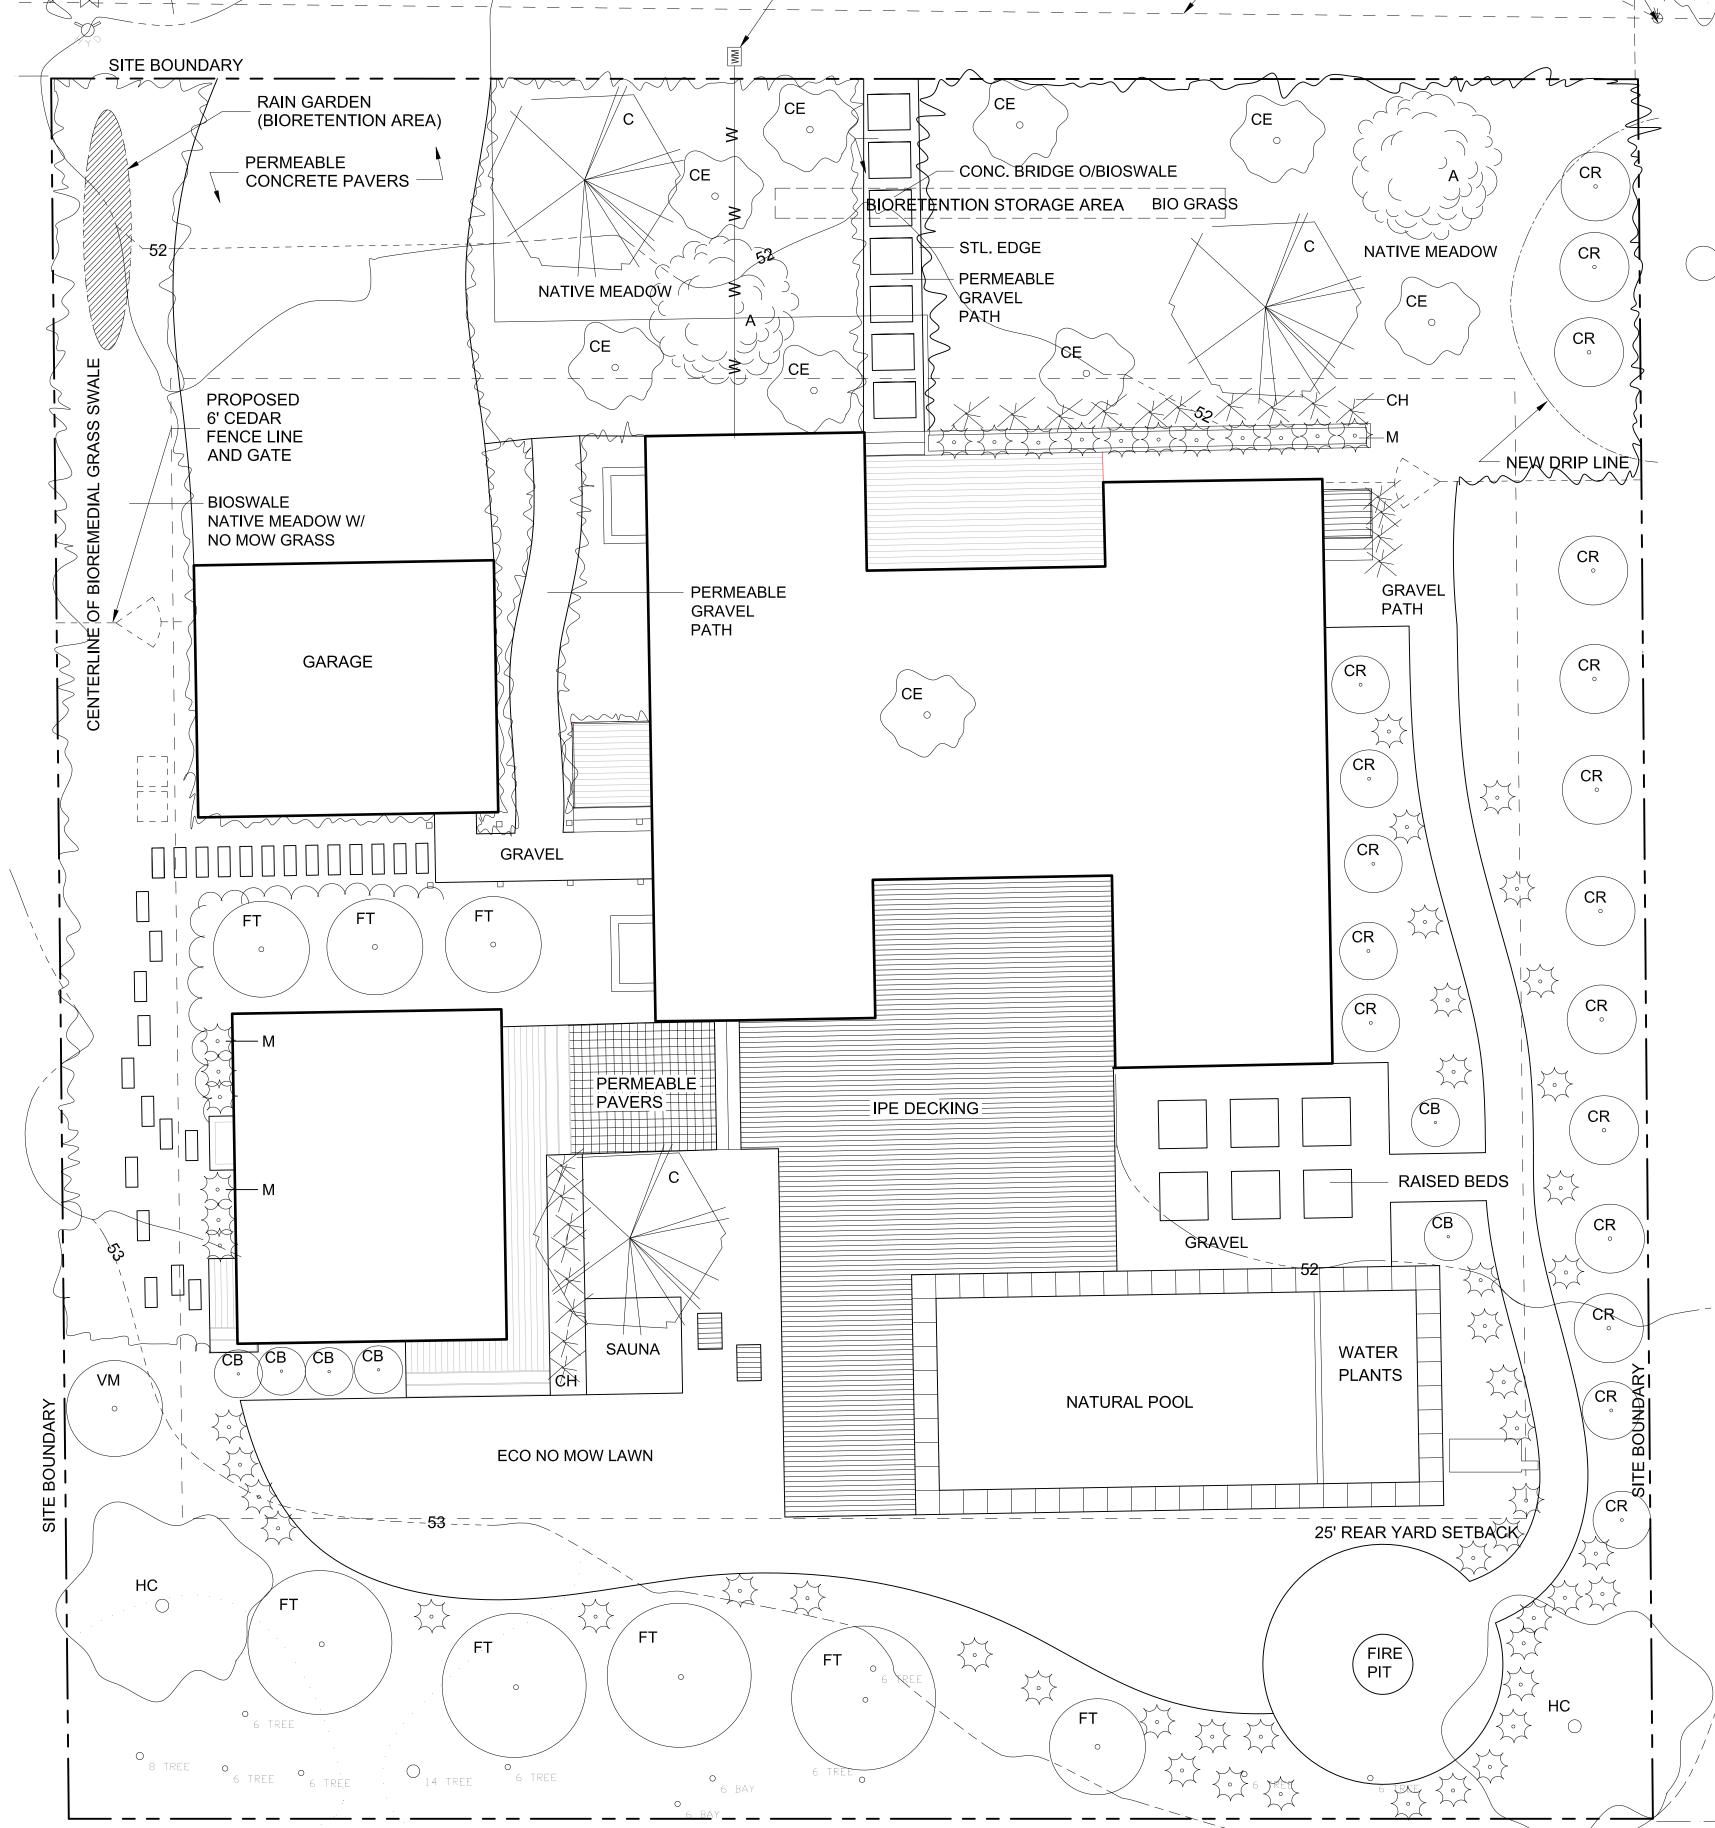

SITE PLAN

DRAWING NO.


S


LANDSCAPE PLAN

SHEET TITLE


MUNDELL S ALTOS, CA

September 22, 2014

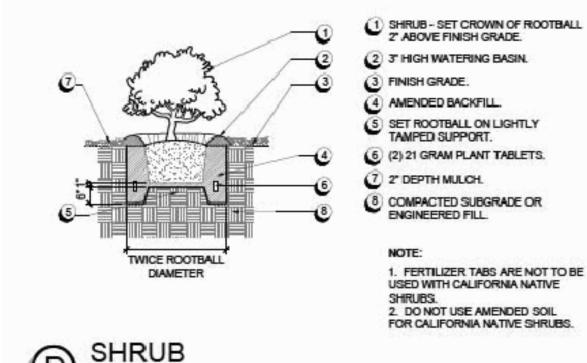

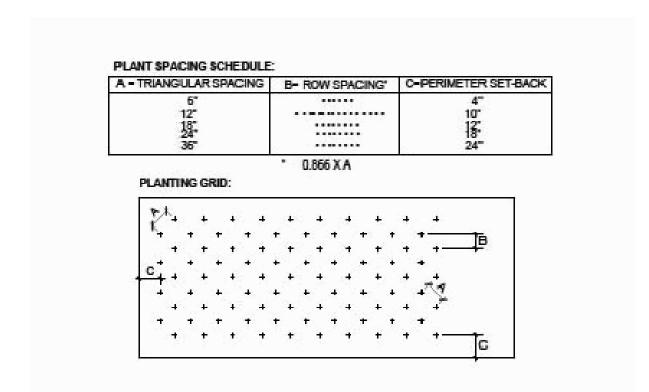

GROUND COVER SPACING CHART

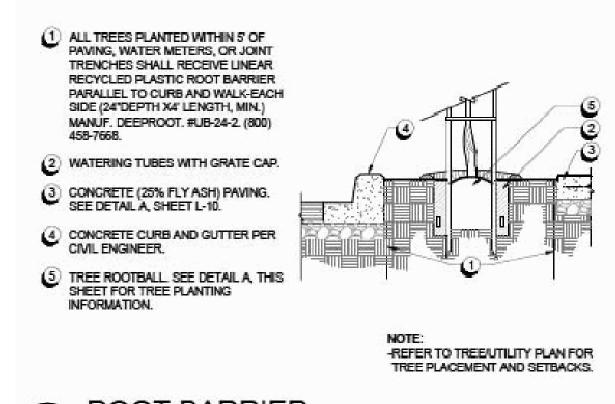


CAL GREEN PERMEABLE PAVING REQUIREMENTS

PER SECTION A4.106.4

SURFACES.

TOTAL AREAS:

PERMEABLE PAVING

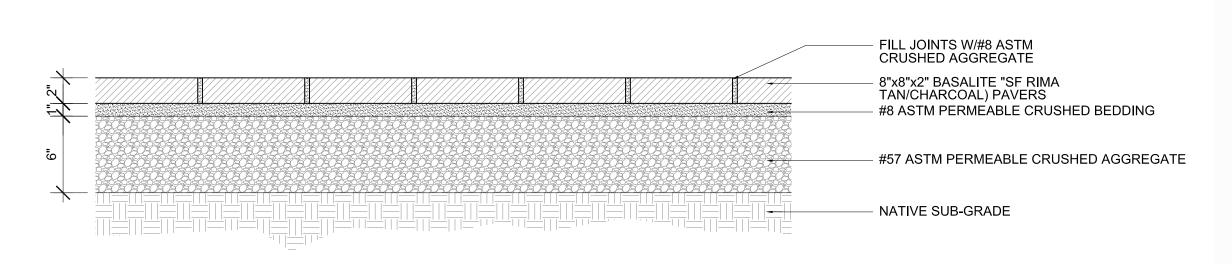

PERMEABLE PAVING SHALL BE UTILIZED FOR 20% OF TOTAL PARKING, WALKING, AND PATIO

DRIVEWAY/PARKING PAVERS

CONCRETE WALKWAY PAVERS

DRIVEWAY/PARKING PAVERS

PERMEABLE PAVED AREA:

PERMEABLE PAVED AREA

TOTAL AREA PROVIDED:

TOTAL PAVED AREA:

20% REQUIRED

AREA REQUIRED 509 S.F. IS LESS THAN AREA PROVIDED 2,478 S.F.

GRAVEL PATHS PAVER PATIO

GRAVEL PATHS

PAVER PATIO

TOTAL PAVED AREA:

986 S.F.

1,412 S.F.

80 S.F.

65 S.F.

2,543 S.F.

986 S.F.

1,412 S.F.

2,478 S.F.

2,543 S.F.

2,478 S.F.


509 S.F.

2,478 S.F.

80 S.F.

F PERMEABLE PAVER SECTION DETAIL

N.T.S.

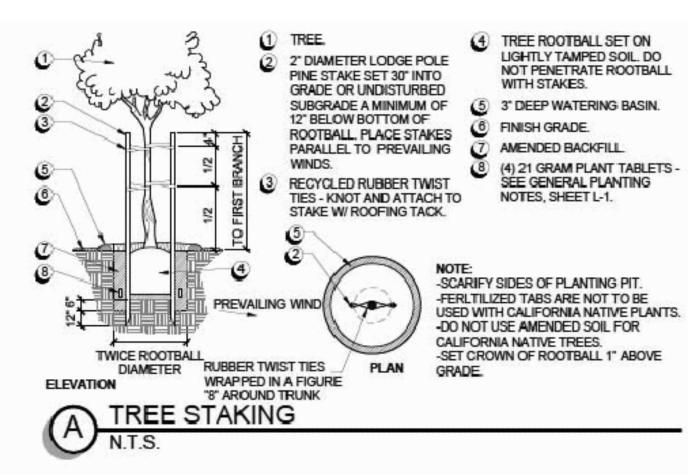

SCHEMATIC DESIGN

S

NOTES/DETAILS


SHEET TITLE


444 MUNDELL WAY LOS ALTOS, CA


September 22, 2014

DATE

DRAWING NO.

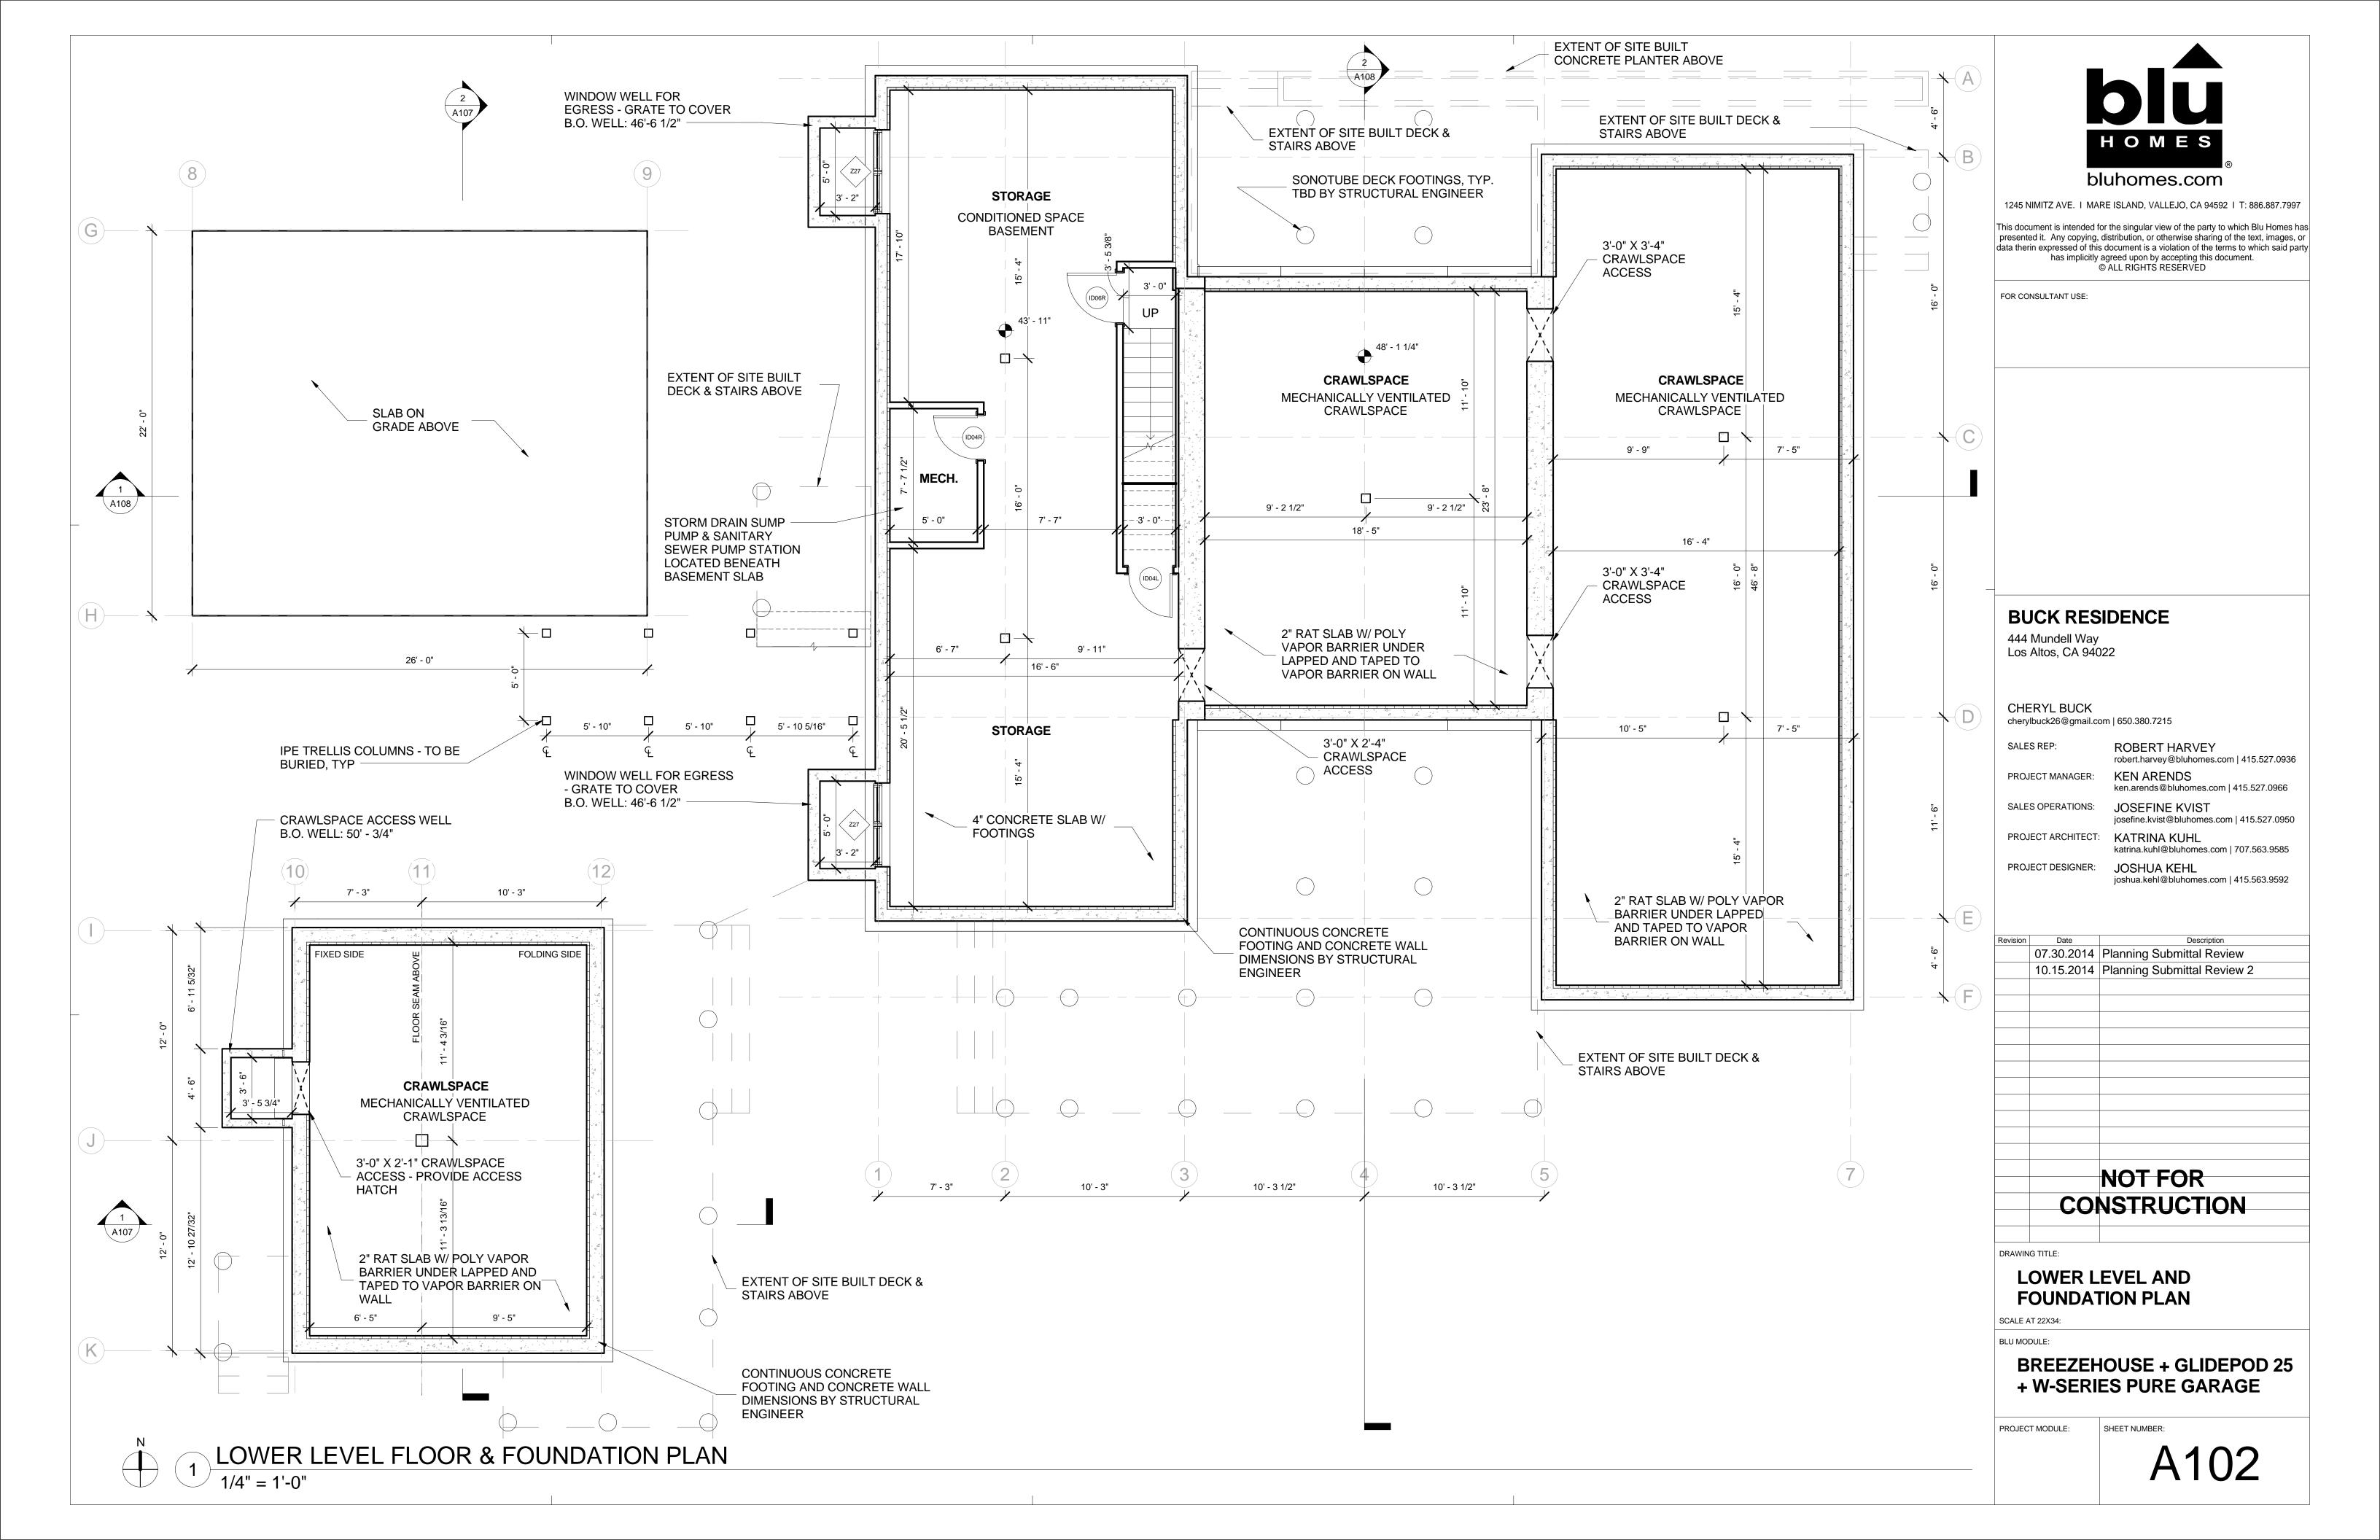

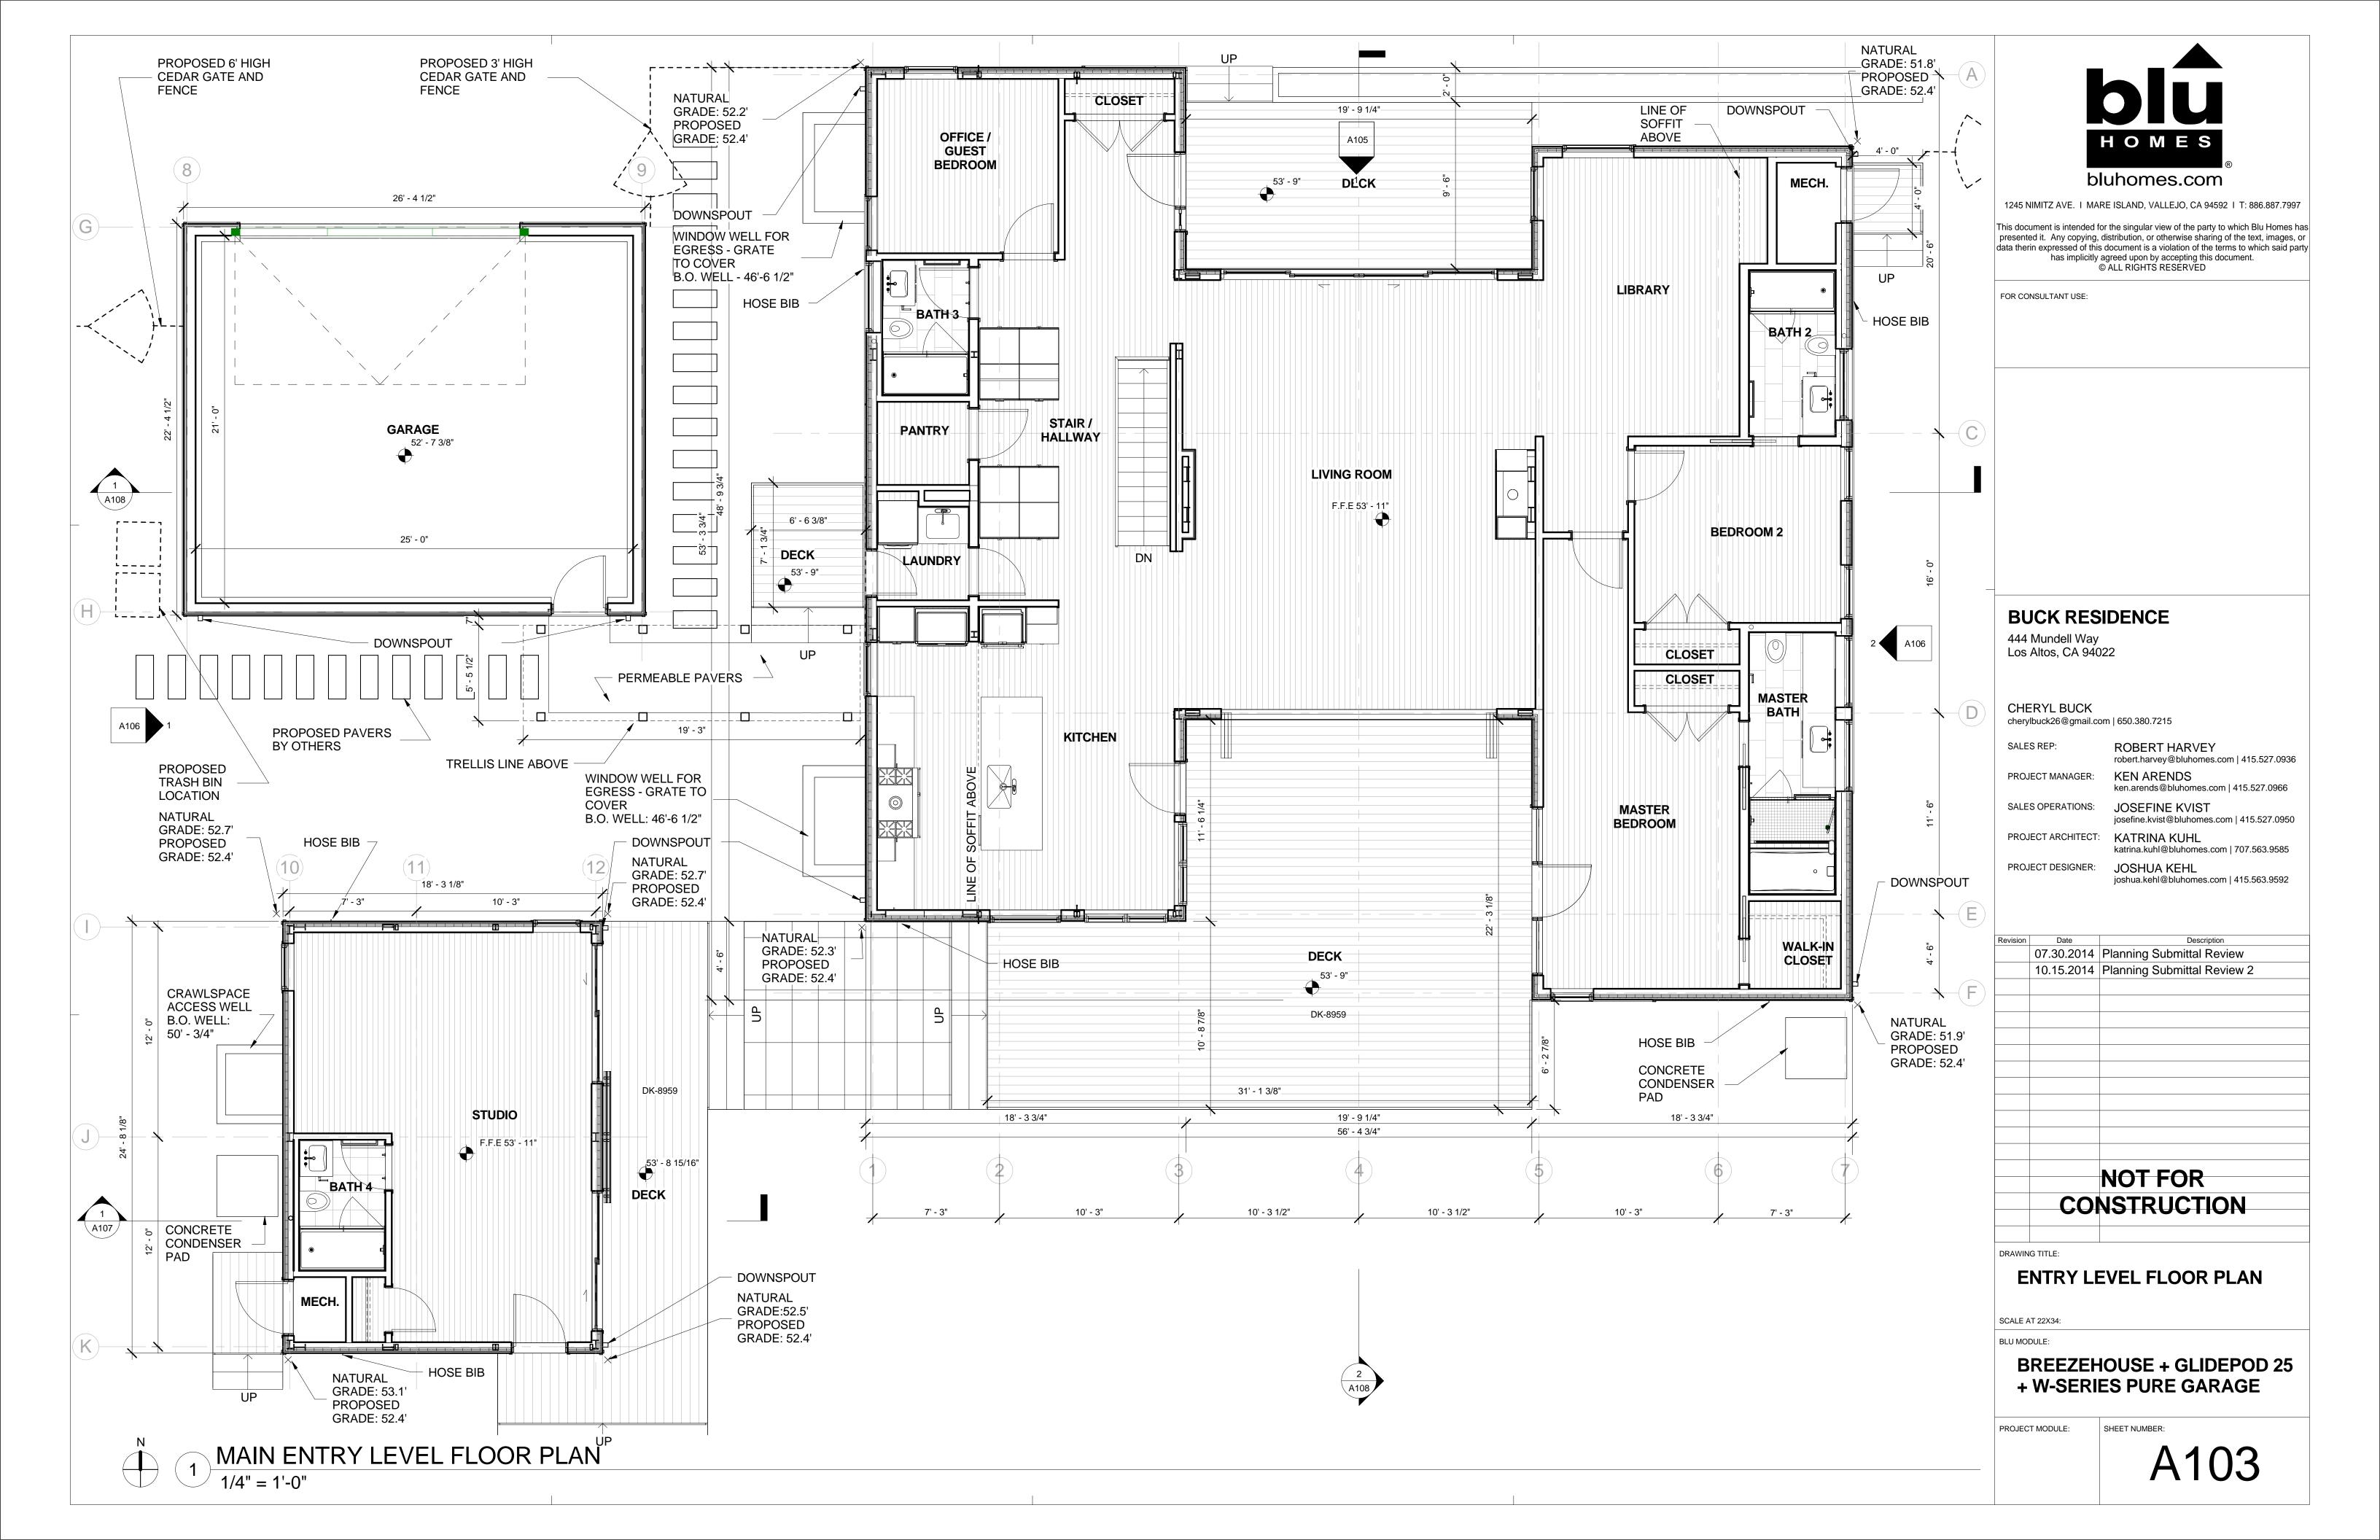

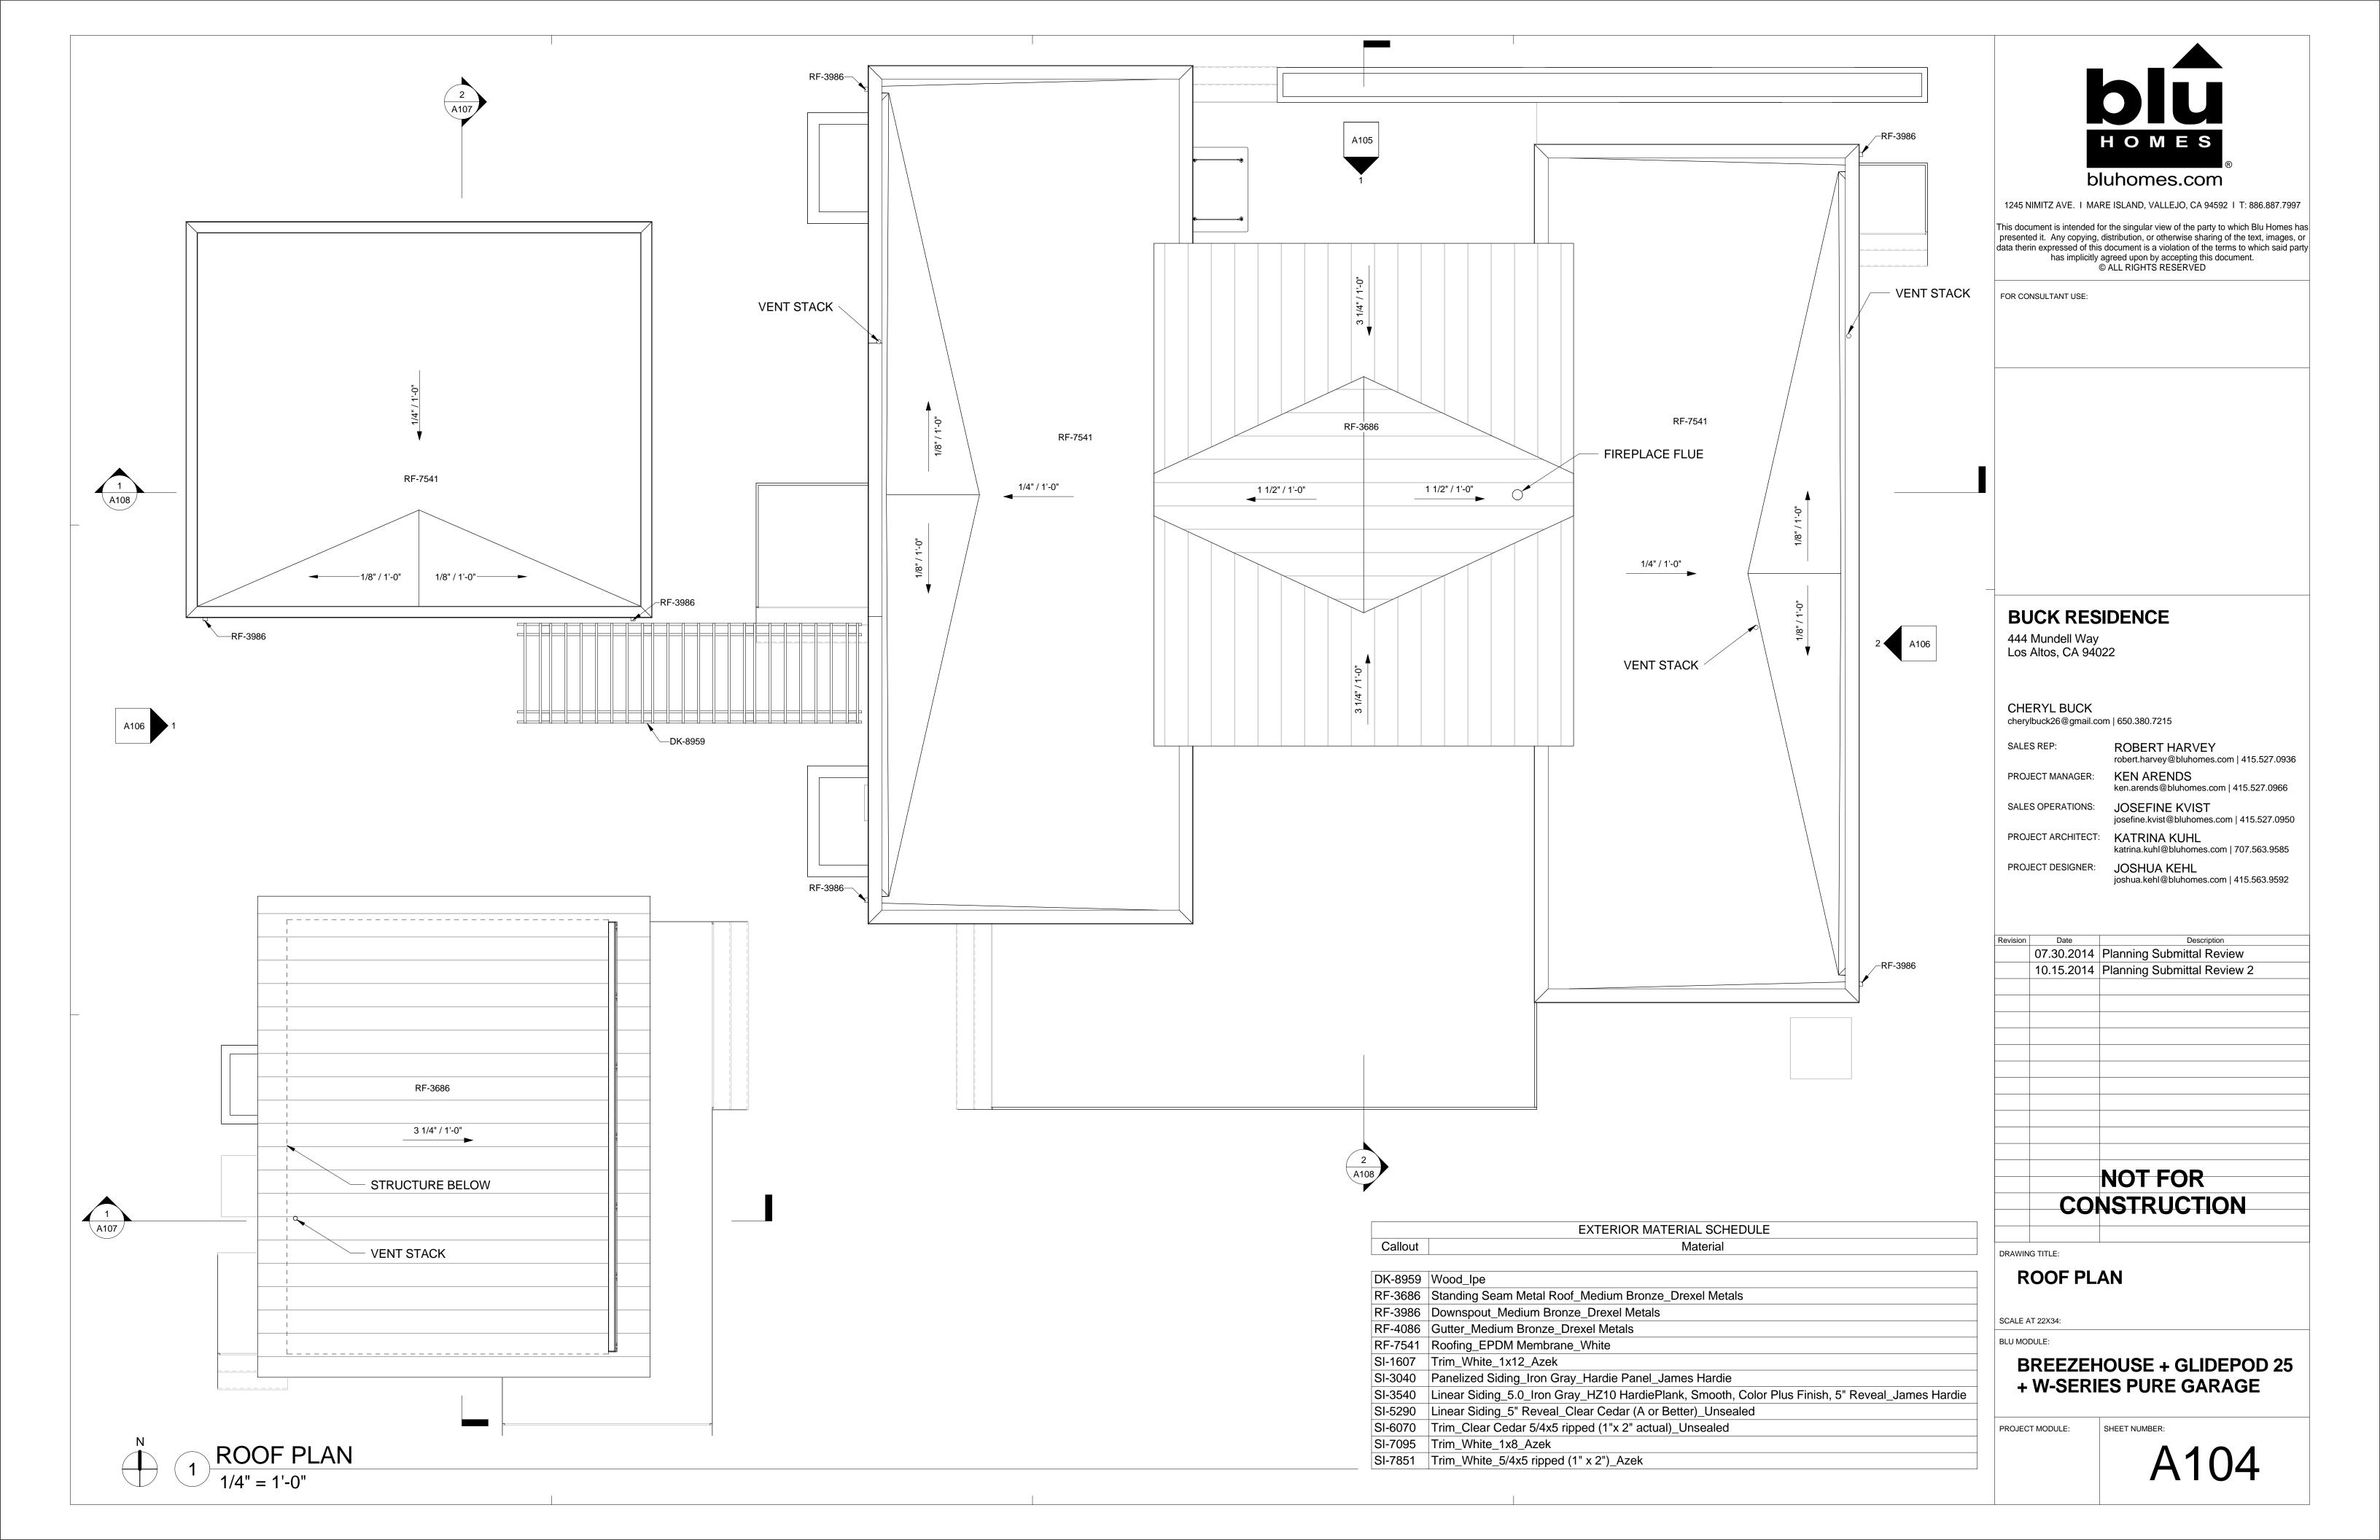

	EXTERIOR MATERIAL SCHEDULE
Callout	Material
DI/ 0050	
DK-8959	Wood_lpe
RF-3686	Standing Seam Metal Roof_Medium Bronze_Drexel Metals
RF-3986	Downspout_Medium Bronze_Drexel Metals
RF-4086	Gutter_Medium Bronze_Drexel Metals
RF-7541	Roofing_EPDM Membrane_White
SI-1607	Trim_White_1x12_Azek
SI-3040	Panelized Siding_Iron Gray_Hardie Panel_James Hardie
SI-3540	Linear Siding_5.0_Iron Gray_HZ10 HardiePlank, Smooth, Color Plus Finish, 5" Reveal_James Hardie
SI-5290	Linear Siding_5" Reveal_Clear Cedar (A or Better)_Unsealed
SI-6070	Trim_Clear Cedar 5/4x5 ripped (1"x 2" actual)_Unsealed
SI-7095	Trim_White_1x8_Azek
SI-7851	Trim_White_5/4x5 ripped (1" x 2")_Azek





1245 NIMITZ AVE. I MARE ISLAND, VALLEJO, CA 94592 I T: 886.887.7997


This document is intended for the singular view of the party to which Blu Homes has presented it. Any copying, distribution, or otherwise sharing of the text, images, or data therin expressed of this document is a violation of the terms to which said party has implicitly agreed upon by accepting this document.

© ALL RIGHTS RESERVED

FOR CONSULTANT USE:

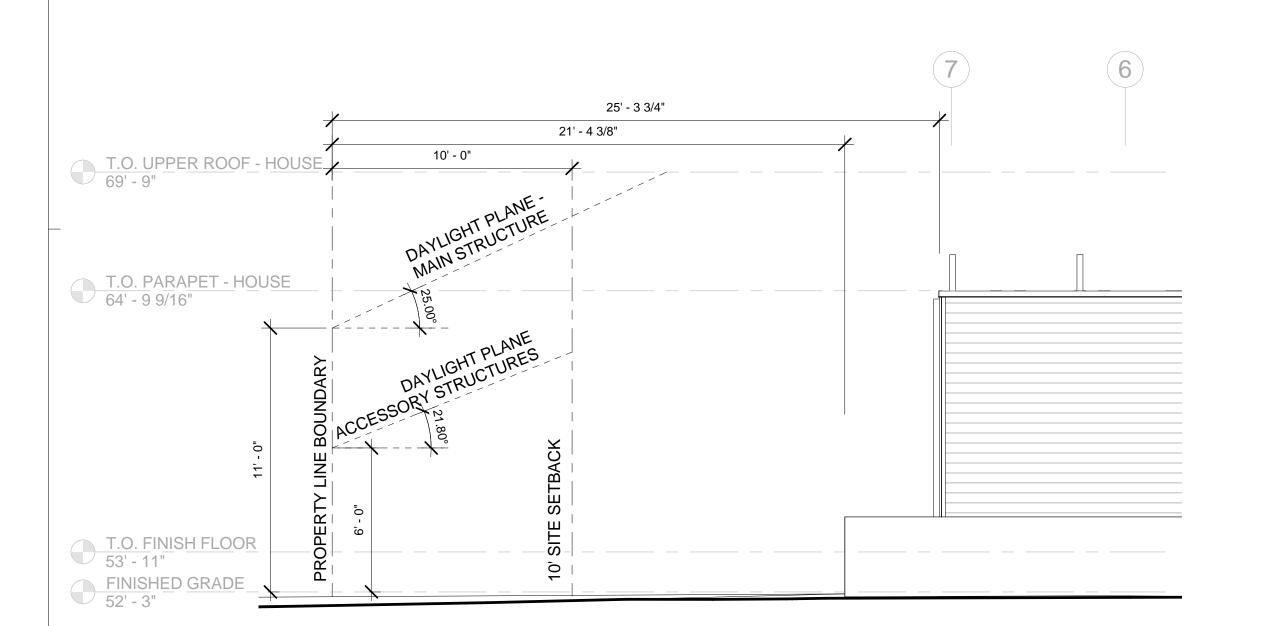

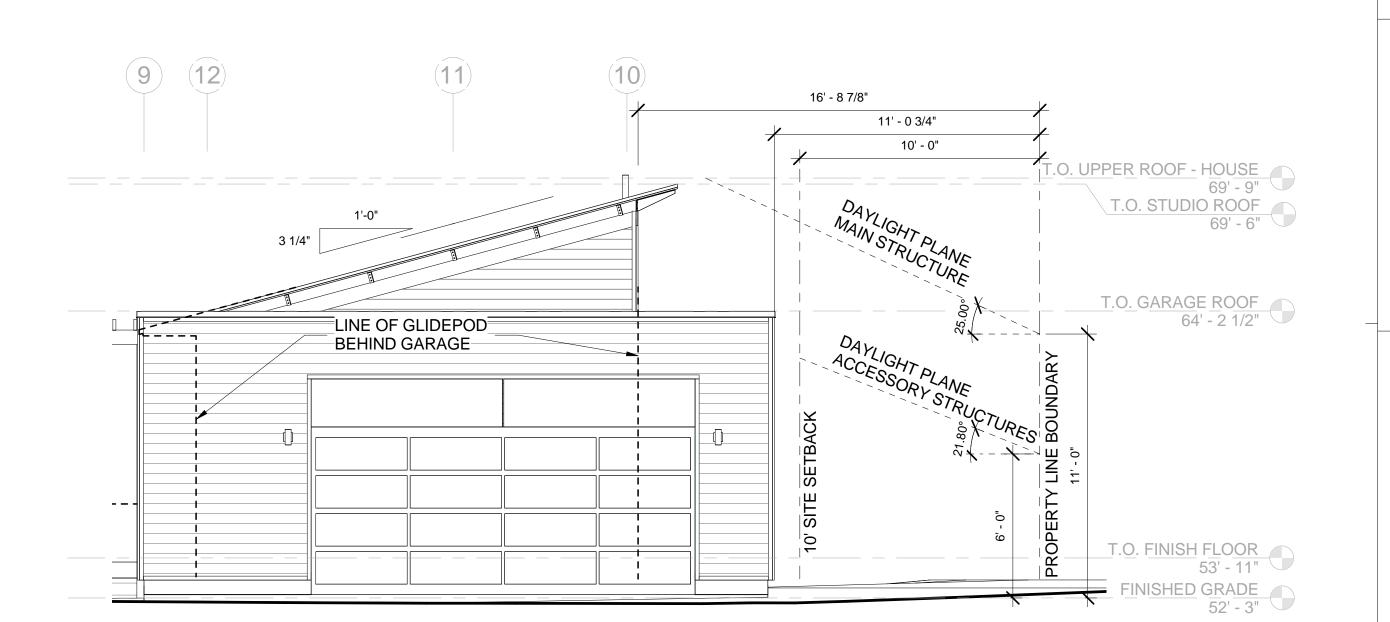

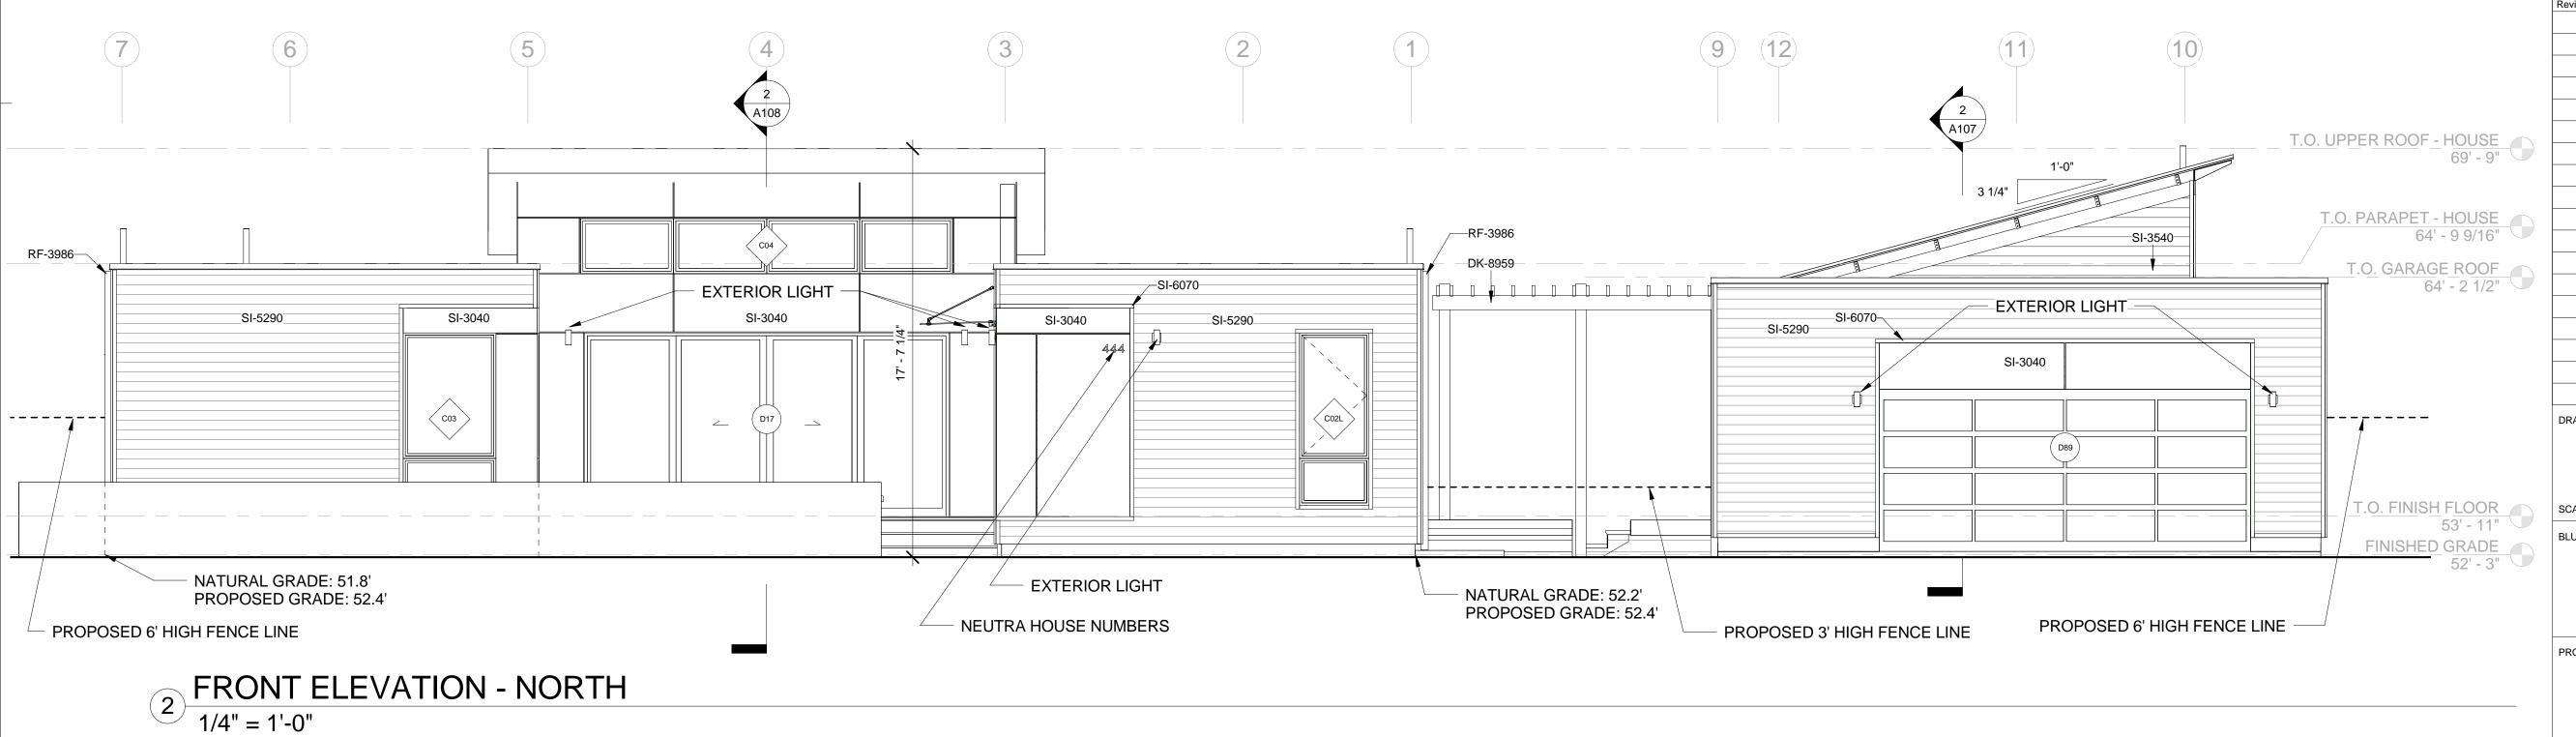

BUCK RESIDENCE

444 Mundell Way Los Altos, CA 94022

CHERYL BUCK cherylbuck26@gmail.com | 650.380.7215

ROBERT HARVEY

robert.harvey@bluhomes.com | 415.527.0936 KEN ARENDS PROJECT MANAGER:

ken.arends@bluhomes.com | 415.527.0966

SALES OPERATIONS: JOSEFINE KVIST

josefine.kvist@bluhomes.com | 415.527.0950 PROJECT ARCHITECT: KATRINA KUHL

katrina.kuhl@bluhomes.com | 707.563.9585

PROJECT DESIGNER: JOSHUA KEHL joshua.kehl@bluhomes.com | 415.563.9592


Revision Date 07.30.2014 Planning Submittal Review 10.15.2014 Planning Submittal Review 2 NOT FOR CONSTRUCTION DRAWING TITLE: **ELEVATIONS AND DAYLIGHT**


PLANE

BREEZEHOUSE + GLIDEPOD 25 + W-SERIES PURE GARAGE


PROJECT MODULE:

SHEET NUMBER: A105

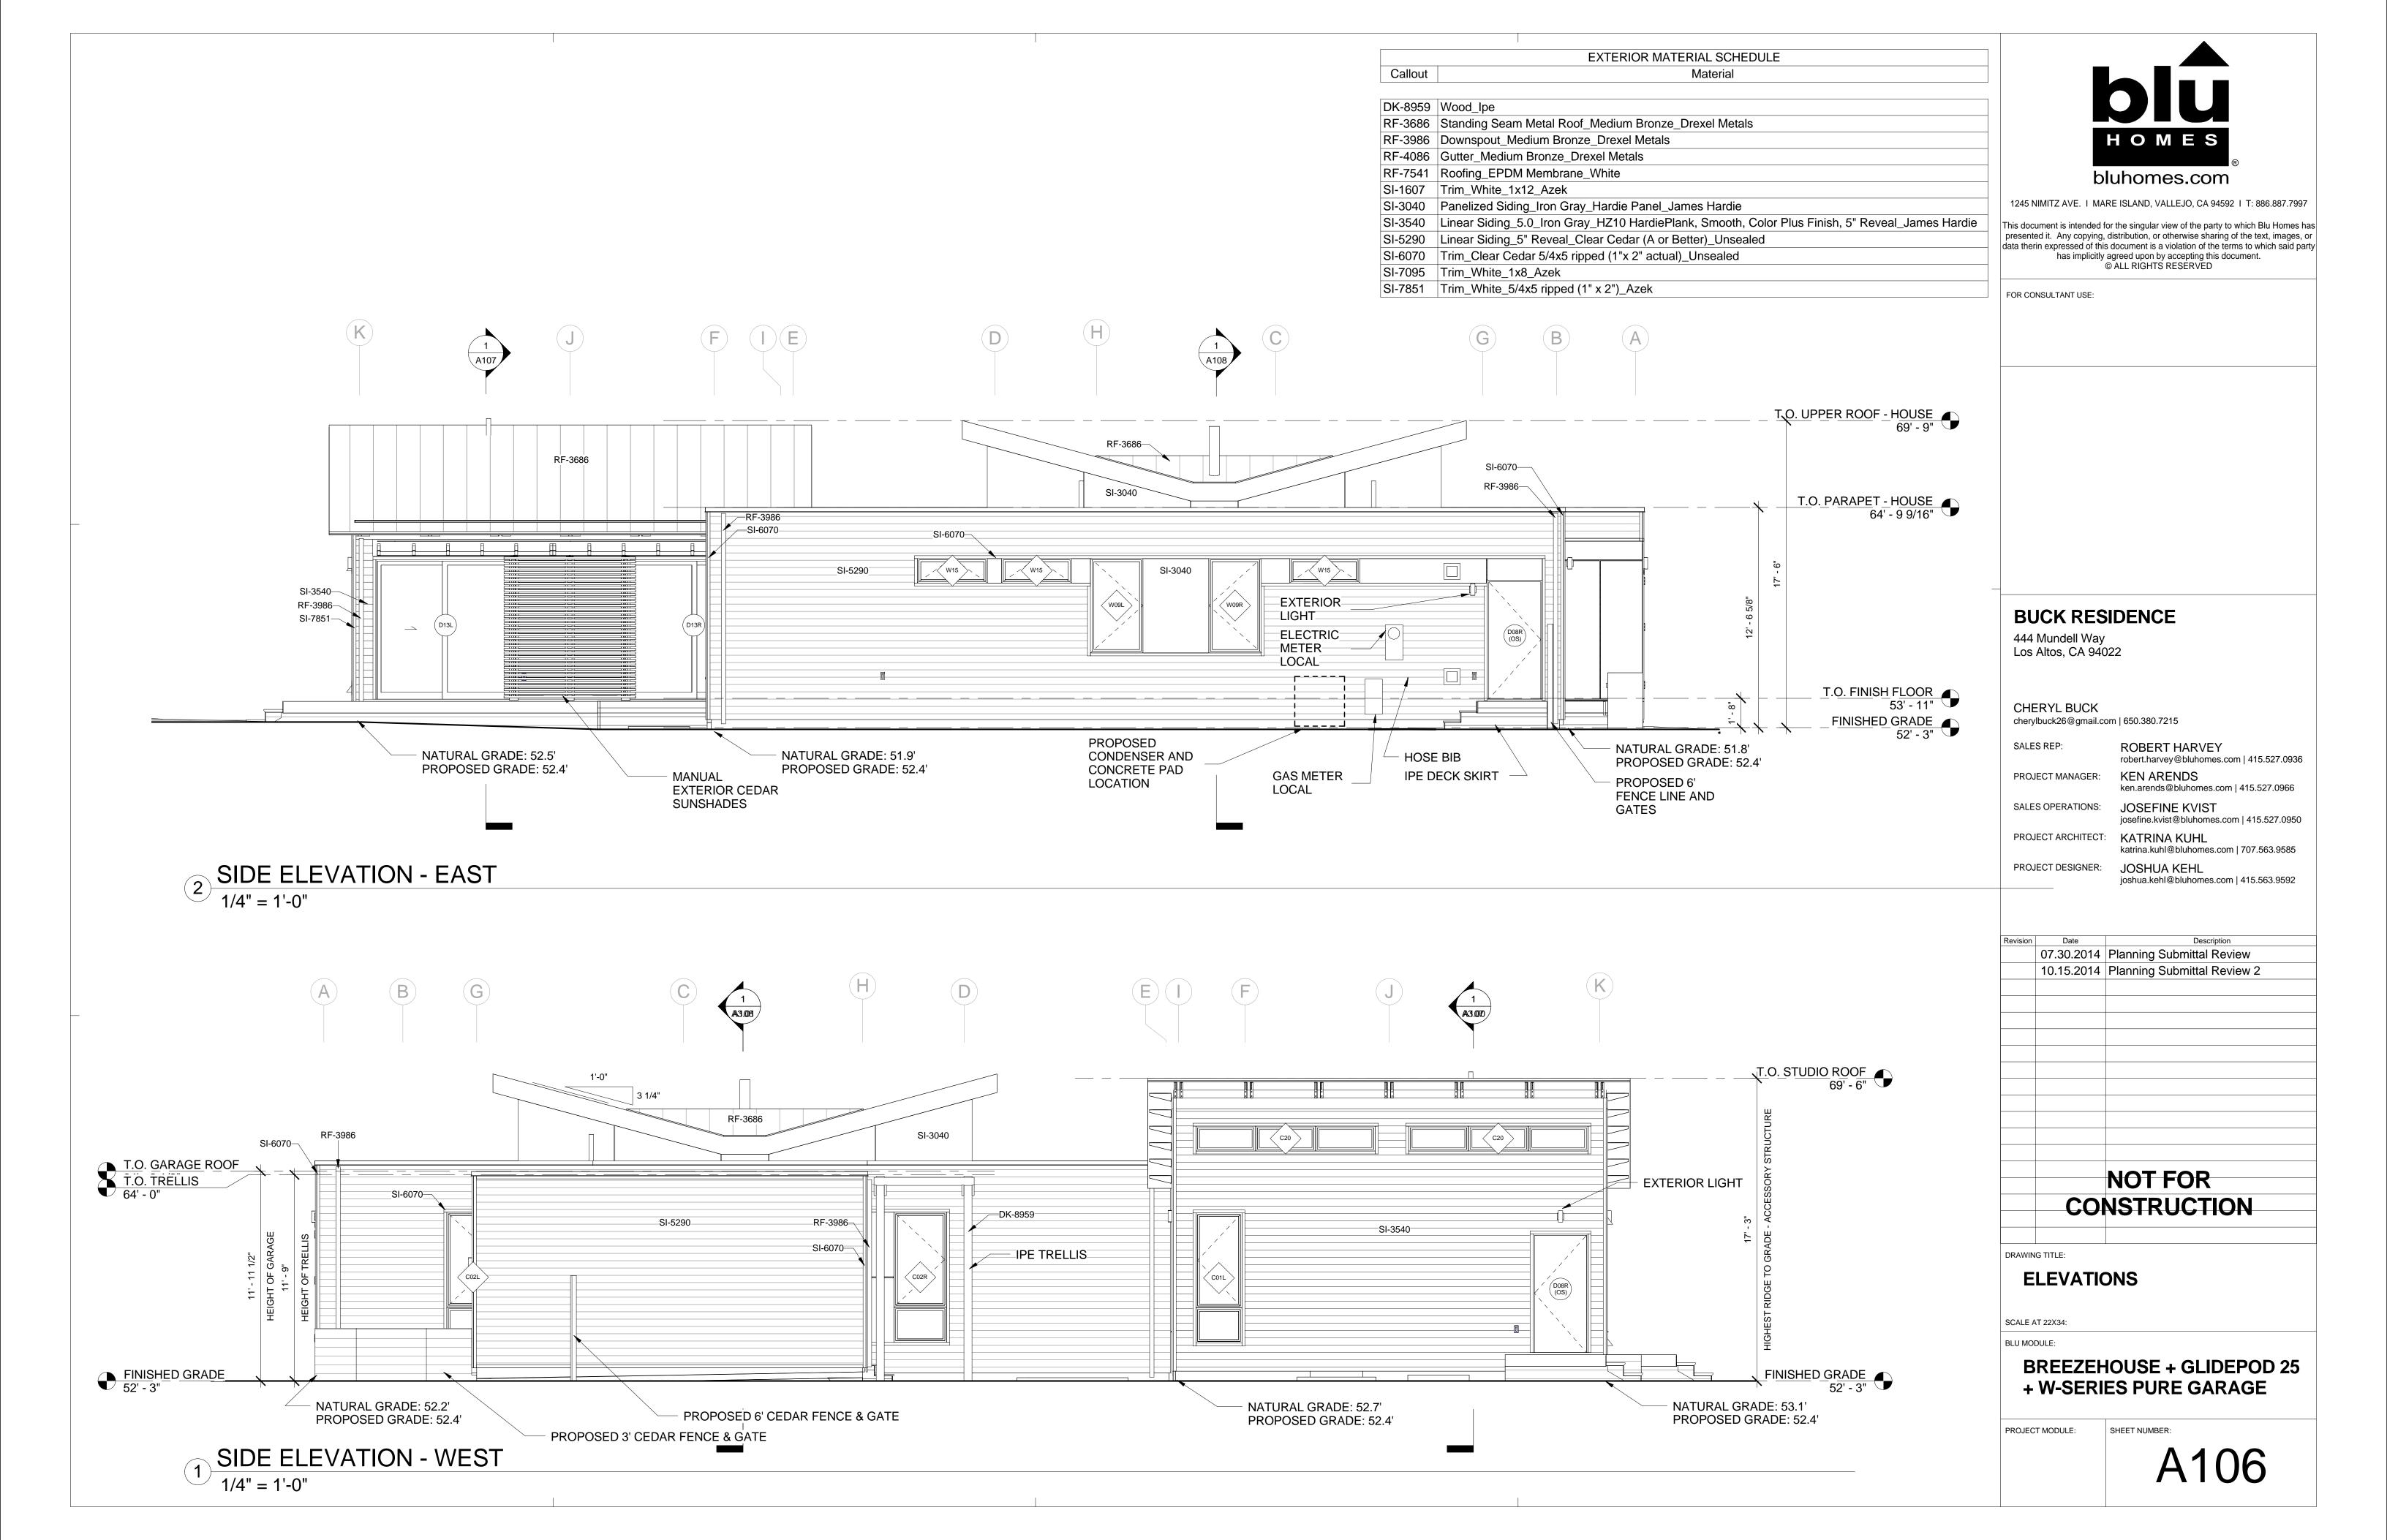

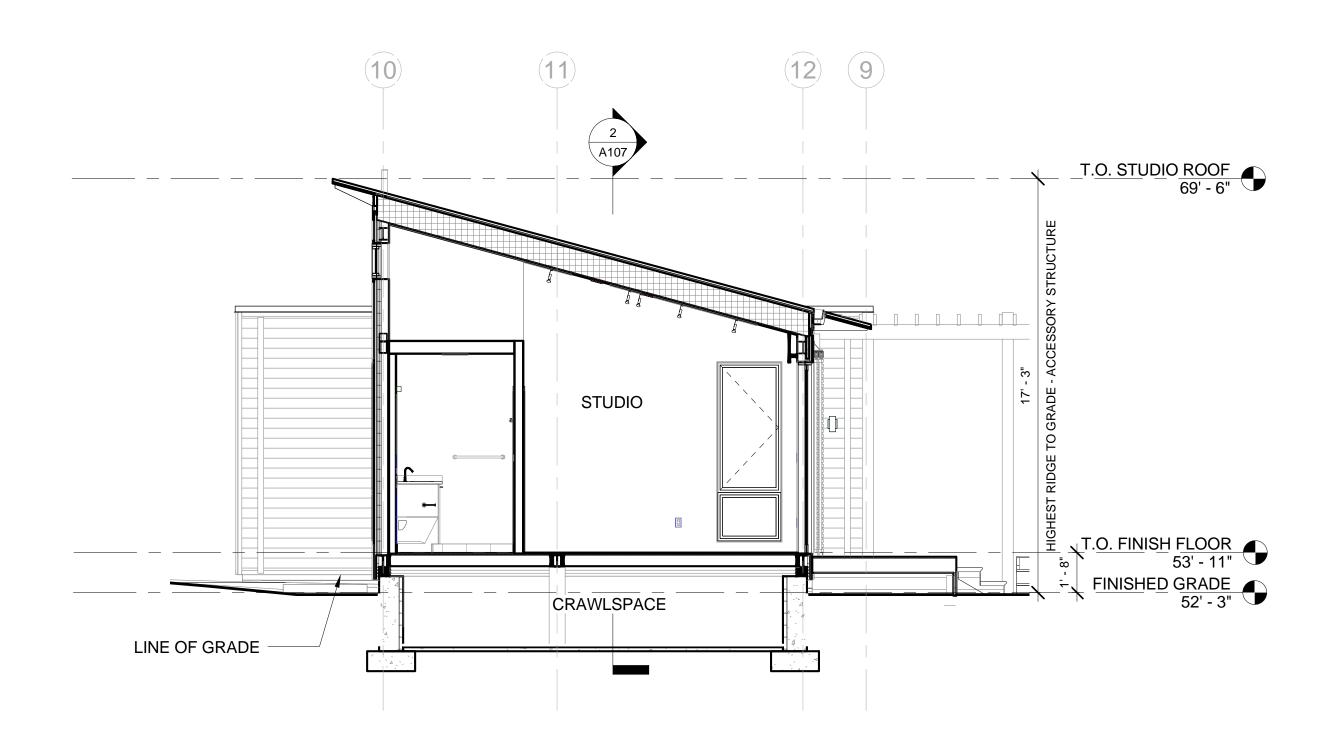

1 SECTION A

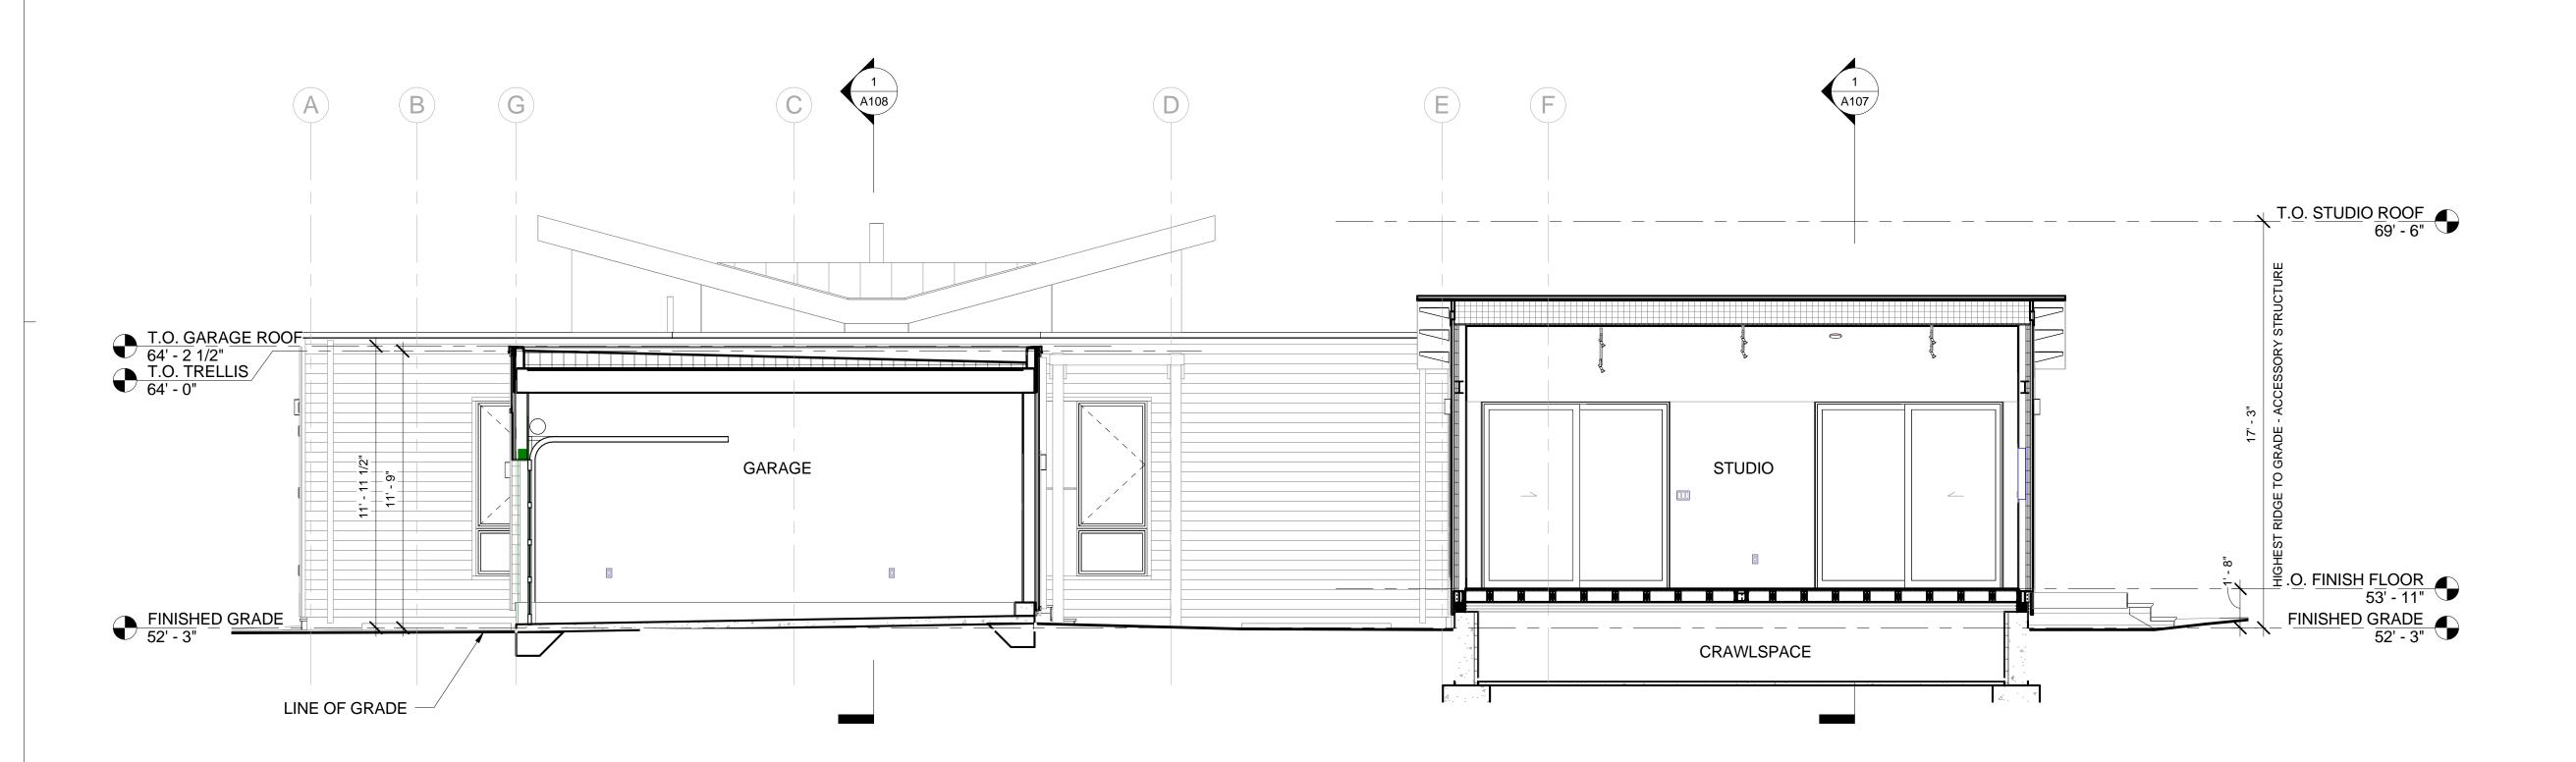



1245 NIMITZ AVE. I MARE ISLAND, VALLEJO, CA 94592 I T: 886.887.7997

This document is intended for the singular view of the party to which Blu Homes has presented it. Any copying, distribution, or otherwise sharing of the text, images, or data therin expressed of this document is a violation of the terms to which said party has implicitly agreed upon by accepting this document.

© ALL RIGHTS RESERVED

FOR CONSULTANT USE:

BUCK RESIDENCE

444 Mundell Way Los Altos, CA 94022

CHERYL BUCK

cherylbuck26@gmail.com | 650.380.7215

SALES REP: ROBERT HARVEY robert.harvey@bluhomes.com | 415.527.0936

PROJECT MANAGER: KEN ARENDS ken.arends@bluhomes.com | 415.527.0966

SALES OPERATIONS: JOSEFINE KVIST

josefine.kvist@bluhomes.com | 415.527.0950

PROJECT ARCHITECT: KATRINA KUHL

katrina.kuhl@bluhomes.com | 707.563.9585

PROJECT DESIGNER: JOSHUA KEHL joshua.kehl@bluhomes.com | 415.563.9592

Revision Date Description
07.30.2014 Planning Submittal Review
10.15.2014 Planning Submittal Review 2

NOT FOR CONSTRUCTION

DRAWING TITLE:

BUILDING SECTIONS

SCALE AT 22X34:

BLU MOD

BREEZEHOUSE + GLIDEPOD 25 + W-SERIES PURE GARAGE

SHEET NUMBER:

PROJECT MODULE:

A107

2 SECTION B 1/4" = 1'-0"

